
# CONSTRUCTION PLANS FOR




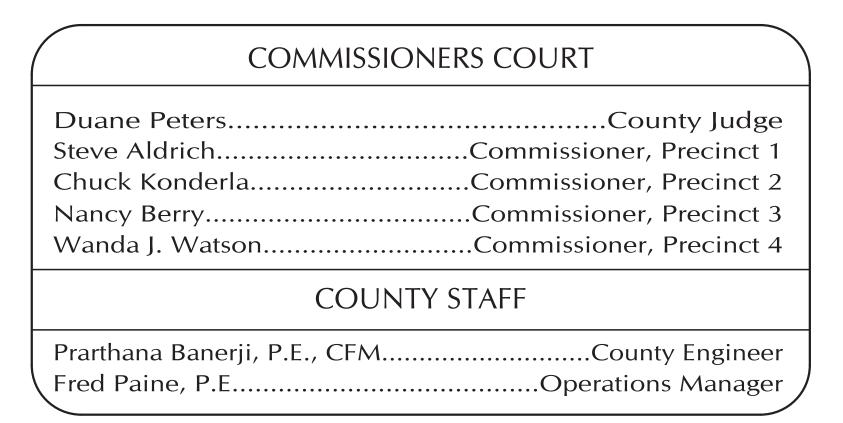


Brazos County, Texas 4153 COUNTY PARK COURT, BRYAN, TEXAS 77802

# Tax Office & AgriLife Site Drainage Improvements

January, 2024

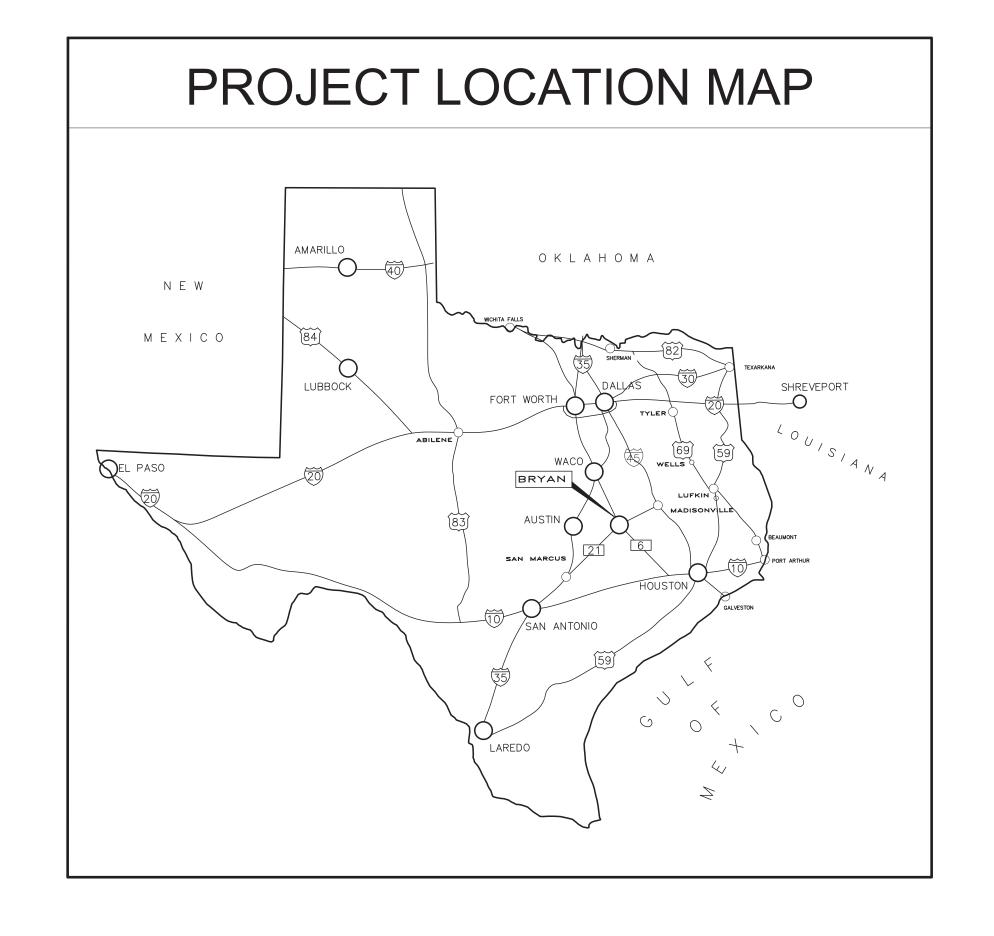

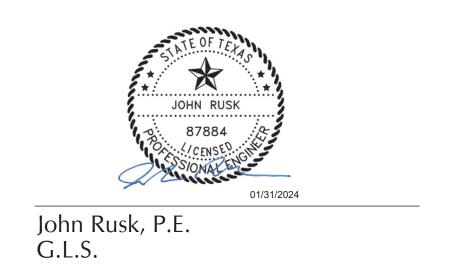

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### PREPARED BY:



ARCHITECTURE - ENGINEERING - INTERIORS LANDSCAPE - SURVEYING

1609 S. CHESTNUT ST. STE. 202 - LUFKIN, TEXAS 75901 - (936) 637-4900 4077 CROSS PARK DR. STE. 100 - BRYAN, TEXAS 77802 - (979) 776-9700 455 RICE ROAD STE. 107 - TYLER, TEXAS 75701 - (903) 581-3805 ©2023 ALL RIGHTS RESERVED BY GOODWIN-LASITER, INC. UNAUTHORIZED USE OR TBPE FIRM REGISTRATION #413 - TBPLS FIRM REGISTRATION #10110900 -TBPLS FIRM REGISTRATION #10110901 D:\619 - BRAZOS COUNTY\619016 - TAX OFFICE & AGRILIFE\619016-C0.0-COVER.D8V(28/2023 10:05 AM

CONSTRUCTION SHALL BE ACCOMPLISHED IN ACCORDANCE WITH THE RULES AND REGULATIONS OF BRAZOS COUNTY AND THESE UTILITY CONSTRUCTION AND MATERIALS SHALL MEET THE REQUIREMENTS OF THESE PLANS: 2020 B/CS UNIFIED DESIGN GUIDELINES, SPECIFICATIONS/PLANS. SPECIFICATIONS AND DETAILS AND TCEQ "RULES & REGULATIONS FOR PUBLIC WATER SYSTEMS". CONTRACTOR SHALL VISIT THE CONSTRUCTION LOCATION AND FAMILIARIZE THEMSELVES WITH THE WORKING CONDITIONS (TRAFFIC, CONTRACTOR AND HIS SUPPLIER TO SUPPLY & INSTALL FITTINGS AS DESIGNED. ANY ADDITIONAL FITTING REQUIRED BUT NOT NOTED ON PLANS BUT NECESSARY FOR CONSTRUCTION WILL BE CONSIDERED SUBSIDIARY. CONTRACTOR TO MAKE THEIR OWN DETERMINATION FOR SUBSIDIARY ITEMS. DEMOLITION WORK, PROPOSED/EXISTING UTILITIES, PAVING, DRAINAGE) OF THE SITE BEFORE BIDDING. COST TO BE INCLUDED IN PIPE BIDS. CONTRACTOR IS TO VERIFY ALL QUANTITIES OF WORK PRIOR TO BIDDING TO PROVIDE A COMPLETE AND APPROVED PROJECT TO CONTRACTOR IS TO COORDINATE BACKFILLING OF ALL ITEMS TO BE CONSTRUCTED WITH THE CONSULTING ENGINEER. ALL UTILITIES TO BE TESTED BRAZOS COUNTY ON BID FORM. IN ACCORDANCE WITH PROJECT SPECIFICATIONS. TESTS TO BE COORDINATED WITH & WITNESSED BY THE CITY INSPECTOR. THE CONTRACTOR IS REQUIRED TO ATTEND A PRE-CONSTRUCTION MEETING WITH COUNTY AND CONSULTING ENGINEER PRIOR TO STARTING WORK. NO WORK IS TO BE PERFORMED UNTIL THIS MEETING IS COMPLETED AND A WRITTEN NOTICE TO PROCEED IS EMBEDMENT REQUIREMENTS NOTED ON THESE PLANS ARE TO BE STRICTLY ADHERED TO. ISSUED BY THE COUNTY TO THE CONTRACTOR. BI-WEEKLY CONSTRUCTION MEETINGS ON SITE DURING CONSTRUCTION ARE ALSO CONTRACTOR SHALL COORDINATE ALL MAIN AND SERVICE CONNECTIONS WITH BRAZOS COUNTY. CONTRACTOR WILL GIVE 72 HOUR NOTICE TO TO BE SCHEDULED WITH THE CONTRACTOR, BRAZOS COUNTY AND CONSULTANT ENGINEER. CUSTOMERS FOR DISRUPTION OF WATER SERVICE. WATER SERVICES SHALL NOT BE INTERRUPTED TO ANY BUSINESS FOR LONGER THAN A SIX IN THE ABSENCE OF SPECIFIC REQUIREMENTS FOR ANY WORK, CONTRACTOR SHALL COORDINATE WITH CONSULTANT ENGINEER FOR HOUR PERIOD. DIRECTION. CONTRACTORS ARE NOT TO PROCEED WITH ANY WORK WITHOUT PROPER AUTHORIZATION OF THE CONSULTANT ENGINEER. PROCEEDING WITHOUT PROPER DIRECTION FROM CONSULTANT ENGINEER OFFICE WILL BE AT THE CONTRACTORS SOLE ALL NECESSARY ADJUSTMENTS TO UTILITY RELATED ITEMS (IE: WATER METERS, VALVE BOXES, GAS METERS, VALVE BOXES, MONITORING WELLS, MANHOLES, ETC.) ARE TO BE SUBSIDIARY. COSTS TO BE INCLUDED IN BID. CONTRACTOR TO MAINTAIN SITE IN "FIRST CLASS" NEAT CONDITION. WORK SITE SHALL BE CLEANED UP AT END OF EACH DAY BY A LICENSED PLUMBER IS REQUIRED FOR ALL WORK RELATED TO WATER AND SANITARY SEWER SERVICES THAT IS ON PRIVATE PROPERTY. REMOVAL OF ANY TRASH AND/OR CONSTRUCTION DEBRIS. BRAZOS COUNTY WILL HAVE FINAL DECISION ON ACCEPTABLE "NEAT" ALL MANHOLES AND STORM INLET TOPS ARE TO BE ADJUSTED FOR TEMPORARY & FINAL GRADES SO THAT TRAFFIC CAN PASS DURING ALL PHASES OF CONSTRUCTION. COSTS SHALL BE INCLUDED IN MANHOLE BIDS. CONTRACTOR SHALL COORDINATE A STATUS OF CONSTRUCTION SEQUENCE OR REQUEST PROPOSED CHANGES IN CONSTRUCTION SEQUENCE. CONSTRUCTION SEQUENCE IS PROVIDED WITHIN CONSTRUCTION PLANS. FINAL DECISION WILL BE MADE BY THE COUNTY TO ALTER SCHEDULE. FOR BIDDING PURPOSES, THE CONSTRUCTION SEQUENCE WITHIN THE PLANS ARE TO BE FOLLOWED. CONTRACTOR SHALL PREPARE SEQUENCING PLAN AT THE TIME OF PRE—CONSTRUCTION MEETING AND WILL UPDATE THE COUNTY AS NEEDED TO BE DETERMINED BY BRAZOS COUNTY. CONTRACTOR SHALL VERIFY LOCATION OF ALL EXISTING UTILITIES, AND SERVICE LINES PRIOR TO EXCAVATING FOR UTILITY PLACEMENT. LOCATING METHODS INCLUDE, BUT ARE NOT LIMITED TO: LOCATING SERVICES, "POT HOLING" WITH WATER, SPOT DIGGING, ETC. COSTS FOR VERIFICATION OF EXISTING UTILITIES, AND TIE-IN LOCATIONS ARE TO BE INCLUDED IN BID. THE EXISTING LINES SHOWN ARE APPROXIMATE, BASED ON UTILITY MARKINGS AND AS-BUILT PLANS. CONTRACTOR TO PROTECT BUILDINGS, UTILITIES, MAIL BOXES, PAVEMENT, TRASH CANS, ETC. FROM DAMAGE DURING CONSTRUCTION. CONTRACTOR SHALL REPAIR DAMAGES RESULTING FROM THEIR ACTIVITIES. COSTS FOR REPAIRS ARE THE RESPONSIBILITY OF THE CONTRACTOR. CONTRACTOR IS RESPONSIBLE FOR LOCATING UNKNOWN UTILITIES AS ENCOUNTERED IN CONSTRUCTION. CONFLICTS WILL NOT BE REASON FOR CONTRACTOR TO CLAIM A DELAY OR ADDITIONAL COST ON THE PROJECT. CONTRACTOR SHALL ALERT THE CONSULTING ENGINEER IMMEDIATELY. CONTRACTOR TO COORDINATE WORK WITH THE FOLLOWING UTILITY COMPANIES, AGENCIES, AND THE CITY: WATER & SEWER . . . . . . . . . CITY OF BRYAN. . . . . . . . . . (979)209-5900 GAS . . . . . . . . . . . DEVON GAS. . . . . . . . . . . . (979)779-4460 CABLE . . . . . . . . . . . . . SUDDENLINK. . . . . . . . . . . . (979)693-8885 CONTRACTOR TO CONTACT UTILITY & PIPELINE COMPANIES FORTY-EIGHT (48) HOURS IN ADVANCE OF WORK IN THE VICINITY OF THEIR LINES. TEXAS ONE CALL SYSTEM IS REQUIRED WITH TICKET NUMBER. 5. CONTRACTOR TO MAINTAIN CLEARANCE OF ALL EXISTING UTILITIES AS REQUIRED BY THE TEXAS COMMISSION ON ENVIRONMENTAL QUALITY (TCEQ) AND THESE PLANS. . REMOVE AND DISPOSE OF ALL MATERIALS AND STRUCTURES THAT ARE TO BE DEMOLISHED AND NOT NOTED FOR SALVAGE IN AN APPROVED CONTRACTOR DISPOSAL AREA. . CONTRACTOR IS RESPONSIBLE FOR IMPLEMENTING AND MAINTAINING A TRAFFIC HANDLING PLAN. PROVIDE PROPER SIGNING FOR CONSTRUCTION, SAFETY, AND ROUTING OF TRAFFIC AT ALL TIMES DURING CONSTRUCTION. ANY DEVIATIONS FROM THIS PLAN SET'S TRAFFIC CONTROL PLAN ARE TO BE APPROVED BY BRAZOS COUNTY. POSITIONING AND CONTENT OF SIGNS, BARRICADES AND FLAGGING SHALL BE IN ACCORDANCE WITH THE CURRENT TEXAS MUTCD. CONTRACTOR SHALL CHECK TRAFFIC CONTROL SIGNAGE . CONTRACTOR TO PROVIDE BARRICADES, SIGNS, AND LIGHTING AROUND ALL OPEN CUTS ALONG STREETS IN ACCORDANCE WITH THE TEXAS MUTCD. CONTRACTOR TO MAINTAIN AN ADA ACCESSIBLE ROUTE TO BUILDINGS AT ALL TIMES. AT LEAST ONE DOORWAY SHALL BE ACCESSIBLE AT ALL TIMES. CONSTRUCTION SHALL BE DONE IN PHASES IN ORDER TO MAINTAIN ACCESS TO BUILDINGS. A PROJECT PHASING PLAN IS PROVIDED IN THESE PLANS. CONTRACTOR SHALL COORDINATE MODIFICATIONS TO THE PHASING PLANS WITH BRAZOS COUNTY AND CONSULTING ENGINEER. A FIELD SET OF AS-BUILT DRAWINGS SHOULD BE MAINTAINED BY THE CONTRACTOR FOR TRANSFER TO PERMANENT RECORD DRAWINGS. THESE DRAWINGS SHOULD INCLUDE MEASUREMENTS FROM EACH UNIT INSTALLED TO TWO PERMANENT OBJECTS. UTILITY SERVICE LOCATIONS SHOULD ALSO BE DOCUMENTED. PROJECT WILL NOT BE CLOSED OUT UNTIL CONTRACTOR HAS PROVIDED THESE FIELD SET(S) TO THE CONSULTING ENGINEER. THESE FIELD SEI(S) TO THE CONSOLTING ENGINEER.

19. CONTRACTOR TO STORE MATERIALS AT LOCATION(S) APPROVED BY & COORDINATED WITH BRAZOS COUNTY. EQUIPMENT IS TO BE

CONTRACTOR TO STORE MATERIALS AT LOCATIONS SO AS NOT TO BLOCK STREETS OR DRIVES. MATERIALS ARE TO BE PROTECTED FROM DAMAGE

Utility Notes O. CONTRACTOR TO MAINTAIN ADEQUATE SITE DRAINAGE FACILITIES AS REQUIRED DURING CONSTRUCTION. PROTECT EXCAVATIONS FROM FLOODING DUE TO GROUNDWATER INFILTRATION AND RUN-OFF. INSURE THAT NO DRAINAGE ON OR OFF THE SITE IS COMPACTED TO A MINIMUM OF 98% STANDARD EFFORT. BLOCKED BY PROPOSED CONSTRUCTION. CONSTRUCTION AREAS ARE TO BE CLEARED/GRUBBED COMPLETELY OF TREES, BRUSH, STUMPS, ROOTS, PIPES, PAVEMENT AND ALL MATERIALS RESULTING FROM DEMOLITION AND CONSTRUCTION. REINFORCING STEEL - ASTM A615, GRADE 60 CONTRACTOR TO BE RESPONSIBLE FOR EROSION CONTROL DURING AND AFTER CONSTRUCTION. CONTRACTOR SHALL INSTALL EROSION AND SILT CONTROL MEASURES AS REQUIRED DURING CONSTRUCTION AND SHALL REMOVE TEMPORARY MEASURES WHEN PERMANENT COVER IS ESTABLISHED. . CONTRACTOR IS RESPONSIBLE FOR O.S.H.A. ESTABLISHED TRENCH SAFETY AS DESCRIBED IN THE FEDERAL REGISTER 29 CFR PART 1926. A TRENCH SAFETY PLAN SHOULD BE PREPARED AND A "COMPETENT PERSON" APPOINTED PRIOR TO ANY AND ALL EXCAVATING OPERATIONS EXCEEDING 5' DEPTH. THE PLAN IS TO BE PREPARED AND SEALED BY A REGISTERED TEXAS PROFESSIONAL ENGINEER AND SHALL BE SUBMITTED TO BRAZOS COUNTY AND CONSULTING ENGINEER PRIOR TO ANY EXCAVATION ON THE PROJECT. INCLUDE PLAN WITH PROJECT SUBMITTALS. 1. EXISTING GRADES SHALL BE RE—ATTAINED AND PROPOSED GRADES SHALL BE ATTAINED BY SHAPING BACKFILL MATERIAL BY CUT AND FILL OPERATIONS. FILL OPERATIONS ARE TO BE ACCOMPLISHED BY PLACING MATERIAL IN 6-INCH (LOOSE MEASURE) LIFTS AND 98% DENSITY AS DETERMINED BY ASTM D698 (STANDARD PROCTOR), OR AS NOTED IN DETAILS. CONTRACTORS (BIDDERS) ARE TO PERFORM THEIR OWN QUANTITIES DETERMINATION PRIOR TO BIDDING. ALL EARTHWORK TO BE INCLUDED IN BID.

25. FINISHED GRADES OF NATURAL GROUND, SOD, PAVEMENT, ETC. TO BE SLOPED TO PROVIDE PROPER DRAINAGE.

7. CONTRACTORS ARE TO COORDINATE THE HOLDING/SUPPORT OF UTILITY POLES WITH RESPECTIVE POLE OWNERS WHERE NECESSARY

TO FACILITATE CONSTRUCTION. ALL COORDINATION WITH UTILITY COMPANIES IS TO BE INCLUDED WITH BID ITEMS FOR WORK TO

8. CULVERTS, DRIVEWAYS, SIDEWALKS, SIGNS, MAILBOXES, ETC. DISTURBED/DAMAGED BY CONSTRUCTION THAT ARE NOT SPECIFIED

). ALL EARTHEN AREAS DISTURBED BY THE CONTRACTOR'S OPERATIONS SHALL BE REGRADED, HYDROMULCHED, AND FERTILIZED.

DEXISTING UTILITY POLES AND WIRES TO BE REMOVED AND DISPOSED OF BY UTILITY COMPANY'S PERSONNEL AND/OR THEIR

CONTRACTOR. THE UTILITY COMPANY'S PERSONNEL AND/OR THEIR CONTRACTOR SHALL BACKFILL THE UTILITY POLE HOLES.

. ITEMS ASSOCIATED WITH GAS SYSTEM ARE TO REMAIN. CONFLICTS TO BE REPORTED TO CONSULTING ENGINEER. GAS FACILITY

. FIBER OPTIC CABLE (FOC) IS IN PROJECT AREA. CONTRACTOR TO HAVE FOC PRECISELY LOCATED, INCLUDING DEPTH, PRIOR TO

3. ITEMS ASSOCIATED WITH FIBER OPTIC CABLE TO REMAIN. CONFLICTS SHALL BE REPORTED TO CONSULTING ENGINEER. FIBER OPTIC

34. VERIFY LOCATION AND GRADE OF STORM SEWER OUTFALLS AND TIE—INS PRIOR TO CONSTRUCTION OF UPSTREAM IMPROVEMENTS.

USED INCLUDE BUT ARE NOT LIMITED TO ROCK FILTER DAMS, HAY BALES, INLET PROTECTION, SILT FENCES, ETC.

PRECAST STORM SEWER INLETS. BRAZOS COUNTY WILL NOT PAY FOR ADJUSTMENTS OR RE-STOCKING FEES.

37. CONTRACTOR TO COORDINATE WITH TRASH COLLECTOR TO ENSURE CONTINUING SERVICE DURING CONSTRUCTION.

5. CONTRACTOR TO MAINTAIN STORM WATER POLLUTION PREVENTION PLAN (SWPPP) ON SITE. BEST MANAGEMENT PRACTICES TO BE

. STORM SEWER INLETS SHALL BE CAST IN PLACE OR PRECAST. CONTRACTOR SHALL VERIFY ALL ELEVATIONS PRIOR TO ORDERING

26. SELECT BORROW MATERIAL SHALL HAVE A PLASTICITY INDEX (PI) OF 8 TO 20.

THIS WORK SHALL BE DONE AS OUTLINED IN THE SPECIFICATION.

OWNER WILL BE NOTIFIED TO ADDRESS THE CONFLICT.

CABLE OWNER WILL BE NOTIFIED TO ADDRESS THE CONFLICT.

EXCAVATION BEGINNING

FOR REMOVAL/REPLACEMENT ARE TO BE RESET/REPLACED AT NO ADDITIONAL COST.

SUBGRADE SHALL BE PREPARED WITH A MINIMUM 8" THICKNESS, STABILIZED AS REQUIRED (TYPE AND PERCENTAGE) BY SOILS TESTING,

MATERIALS TO BE AS FOLLOWS: CONCRETE - 28-DAY COMPRESSIVE STRENGTH = 3500 PSI

THE FOLLOWING CONCRETE COVER SHALL BE PROVIDED FOR REINFORCING STEEL, UNLESS OTHERWISE SHOWN:

3" - CONCRETE CAST DIRECTLY AGAINST THE GROUND 2" - FORMED SURFACES OR TOP OF FINISHED SURFACES

LAP REINFORCING STEEL IN ACCORDANCE WITH ACI 318-02 (CLASS B). ALL DOWELS SHOULD BE PLACED STRAIGHT IN CONCRETE (NO BENDING) BY USING A DOWEL BASKET, ETC.

PAVING RECONSTRUCTION IS NOT TO PROCEED UNTIL UTILITY CONSTRUCTION IS SUCCESSFULLY TESTED, NEW SYSTEM IS OPERATING, & ABANDONMENT OF OLD SYSTEM IS COMPLETE.

EXCESS DIRT FROM EXCAVATION SHALL BE DISPOSED OF BY THE CONTRACTOR.

PAVEMENT RECONSTRUCTION SHALL BE ACCOMPLISHED IN ACCORDANCE WITH THE RULES AND REGULATIONS OF BRAZOS COUNTY AND THESE SPECIFICATIONS/PLANS.

PAVEMENT TIE-INS TO EXISTING PAVEMENT TO BE SUBSIDIARY TO THE PERTINENT BID ITEMS, SHALL BE SLOPED TO MATCH ADA REQUIREMENTS, BRAZOS COUNTY SPECIFICATIONS, AND TO ENSURE PROPER DRAINAGE.

COORDINATE CONSTRUCTION CLOSELY WITH CONSULTING ENGINEER TO ASSURE THAT THERE ARE NO CONFLICTS BETWEEN GRADING, DRAINAGE AND PAVING IMPROVEMENTS.

. PROPOSED PAVEMENT ELEVATIONS SHOWN ARE TOP OF FINISHED PAVEMENT (P), OR CURB (T) AS NOTED. PROPOSED FLOWLINE ELEVATIONS ARE NOTED (FL).

PROVIDE EXPANSION JOINTS AND CONTROL JOINTS IN ACCORDANCE WITH CONSTRUCTION PLANS, BRAZOS COUNTY SPECIFICATIONS AND DETAILS. CURB AND GUTTER SHALL HAVE 1/2" PREMOLDED OR 3/4" REDWOOD OR CYPRESS EXPANSION JOINT AS DETAILED (UNLESS NOTED OTHERWISE). AND SHALL HAVE GROOVED CONTROL JOINTS AS DETAILED. ALL JOINTS WILL BE SEALED IN ACCORDANCE W/TECHNICAL SPECIFICATIONS. EXPANSION JOINTS FOR CURB AND GUTTER SHALL MATCH EXPANSION JOINTS IN STREET.

ALL FORMS MUST BE WELL STAKED AND THOROUGHLY BRACED SO THAT TAMPING OF MATERIALS WILL NOT DISTURB THEM OR MOVE THEM OUT OF

CARE MUST BE TAKEN THAT THE CURB AND GUTTER SHALL NOT SHOW TROWEL MARKS, HIGH SPOTS, SAGS OR HORIZONTAL DEFLECTIONS AND ANY SECTION SHOWING SAME AFTER BEING FINISHED WILL NOT BE ACCEPTED BY BRAZOS COUNTY AND MUST BE REPLACED BY THE CONTRACTOR OTHER CONCRETE IMPERFECTIONS ON SIDEWALK & OTHER STRUCTURES ARE TO BE HANDLED IN SIMILAR FASHION TO ENSURE HIGH QUALITY.

THE COMPLETED CONCRETE PAVEMENT SHALL BE CURED BY A METHOD APPROVED BY BRAZOS COUNTY. LIQUID MEMBRANE CURING COMPOUND WHICH COMPLIES WITH THE "STANDARD SPECIFICATIONS FOR LIQUID MEMBRANE FORMING COMPOUNDS FOR CURING CONCRETE", ASTM C309 TYPE 2 WHITE PIGMENTED MAY BE USED.

TRAFFIC PAINT SHALL BE APPLIED ONLY AFTER PAVEMENT HAS BEEN PRIMED AND THOROUGHLY CLEANED PER TECHNICAL SPECIFICATIONS AT TIME OF APPLICATION TO REMOVE CURING COMPOUND. CONTRACTOR TO CONFIRM THERE ARE NO ISSUES W/ PAVING NOTE #15 PRIOR TO PAINTING/STRIPING.

Call 8 Before You Dig

N.T.S.

**Utility Locate Service** 

Bench Mark List DESCRIPTION COORD./ELEV 'RJ BM CITY OF COLLEGE STATION MONUMENT CS94-126 (ELEVATION DATUM N: 10221519.22 NAVD 1988, GEOID09) E: 3566228.08 ELEV: 286.21 5/8" IRON ROD WITH RED PLASTIC CAP STAMPED 'KERR SURV. CONTROL POINT' SET ALONG COUNTY PARK CT. APPROXIMATELY 13' IN N: 10225993.85 A NORTHEASTERLY DIRECTION FROM THE CURB INLET NEAREST TO THE E: 3565310.56 CUL-DE-SAC ON THE NORTHEASTERN SIDE OF THE COUNTY PARK ELEV: 293.75 COURT, AND APPROXIMATELY 31' IN A NORTHWESTERLY DIRECTION FROM THE LIGHT POLE NEAREST TO THE SAME CURB INLET. 2 | 5/8" IRON ROD WITH RED PLASTIC CAP STAMPED 'KERR SURV. CONTROL POINT' SET APPROXIMATELY 16' BEHIND THE CURB ON THE N: 10225938.56 WESTERN END OF THE PARKING LOT FOR THE AGRILIFE BUILDING. E: 3565039.45 APPROXIMATELY 76' IN A SOURTHWESTERLY DIRECTION FROM THE ELEV: 293.35 NORTHWESTERN CORNER OF THE PARKING LOT NEAREST TO THE CUL-DE-SAC, AND APPROXIMATELY 70' IN A WESTERLY DIRECTION FROM THE NORTHWESTERN CORNER OF THE AGRILIFE BUILDING. 5/8" IRON ROD WITH RED PLASTIC CAP STAMPED 'KERR SURV. CONTROL POINT' SET ON THE WESTERN SIDE OF THE DUMPSTER ENCLOSURE FOR THE BRAZOS COUNTY APPRAISAL DISTRICT. N: 10225677.26 APPROXIMATELY 8' IN A WESTERLY DIRECTION FROM THE E: 3565113.48 NORTHWESTERN CORNER OF THE DUMPSTER ENCLOSURE, AND ELEV: 288.57 APPROXIMATELY 18' IN A SOUTHWESTERLY DIRECTION FROM THE SOUTHEASTERN CORNER OF THE GRATE INLET ADJACENT TO THE TAX OFFICE PARKING LOT.

COORDINATES SHOWN HEREON ARE TEXAS STATE PLANE

CENTRAL ZONE GRID (NOT SURFACE) NAD 83 COORDINATES

Existing **EXISTING RIGHT-OF-WAY** SANITARY SEWER WATER LINE NATURAL GAS LINE UNDERGROUND ELECTRIC LINE UNDERGROUND TELEPHONE LINE UNDERGROUND FIBER OPTIC CABLE OVERHEAD ELECTRIC IRRIGATION CONTROL VALVE FIRE HYDRANT WATER VALVE SANITARY SEWER MANHOLE SANITARY SEWER CLEANOUT  $\bigcirc$  co POWER POLE **GUY WIRE** ☐ WM WATER METER ☐ TBX TELEPHONE BOX △ GM GAS METER <del>- ← −</del> BM#2 BENCH MARK CONTROL POINT ASPHALT GRAVEL CONCRETE

## Proposed

STORM SEWERLINE (SIZE NOTED) STORM SEWER INLET (SIZE NOTED) SIGN (TYPE NOTED) CONCRETE SIDEWALK PAVEMENT HYDROMULCH SEEDED AREA SODDED AREA

RELOCATED TREE

JOHN RUSK 87884

JIR

T.B.P.E.L.S FIRM NO. F-41

T.B.A.E. FIRM NO. BR 351

T.B.P.E.L.S FIRM NO. 10110900

T.B.P.E.L.S FIRM NO. 1011090


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G=GROUND T=TOP OF CURB NOTE: LEGENDS WITHIN SPECIFIC SECTIONS APPLY P=TOP OF PAVEMENT ONLY TO THOSE SECTIONS. THE ITEMS LISTED ABOVE ARE TYPICAL UNLESS NOTED OTHERWISE FL=FLOW LINE




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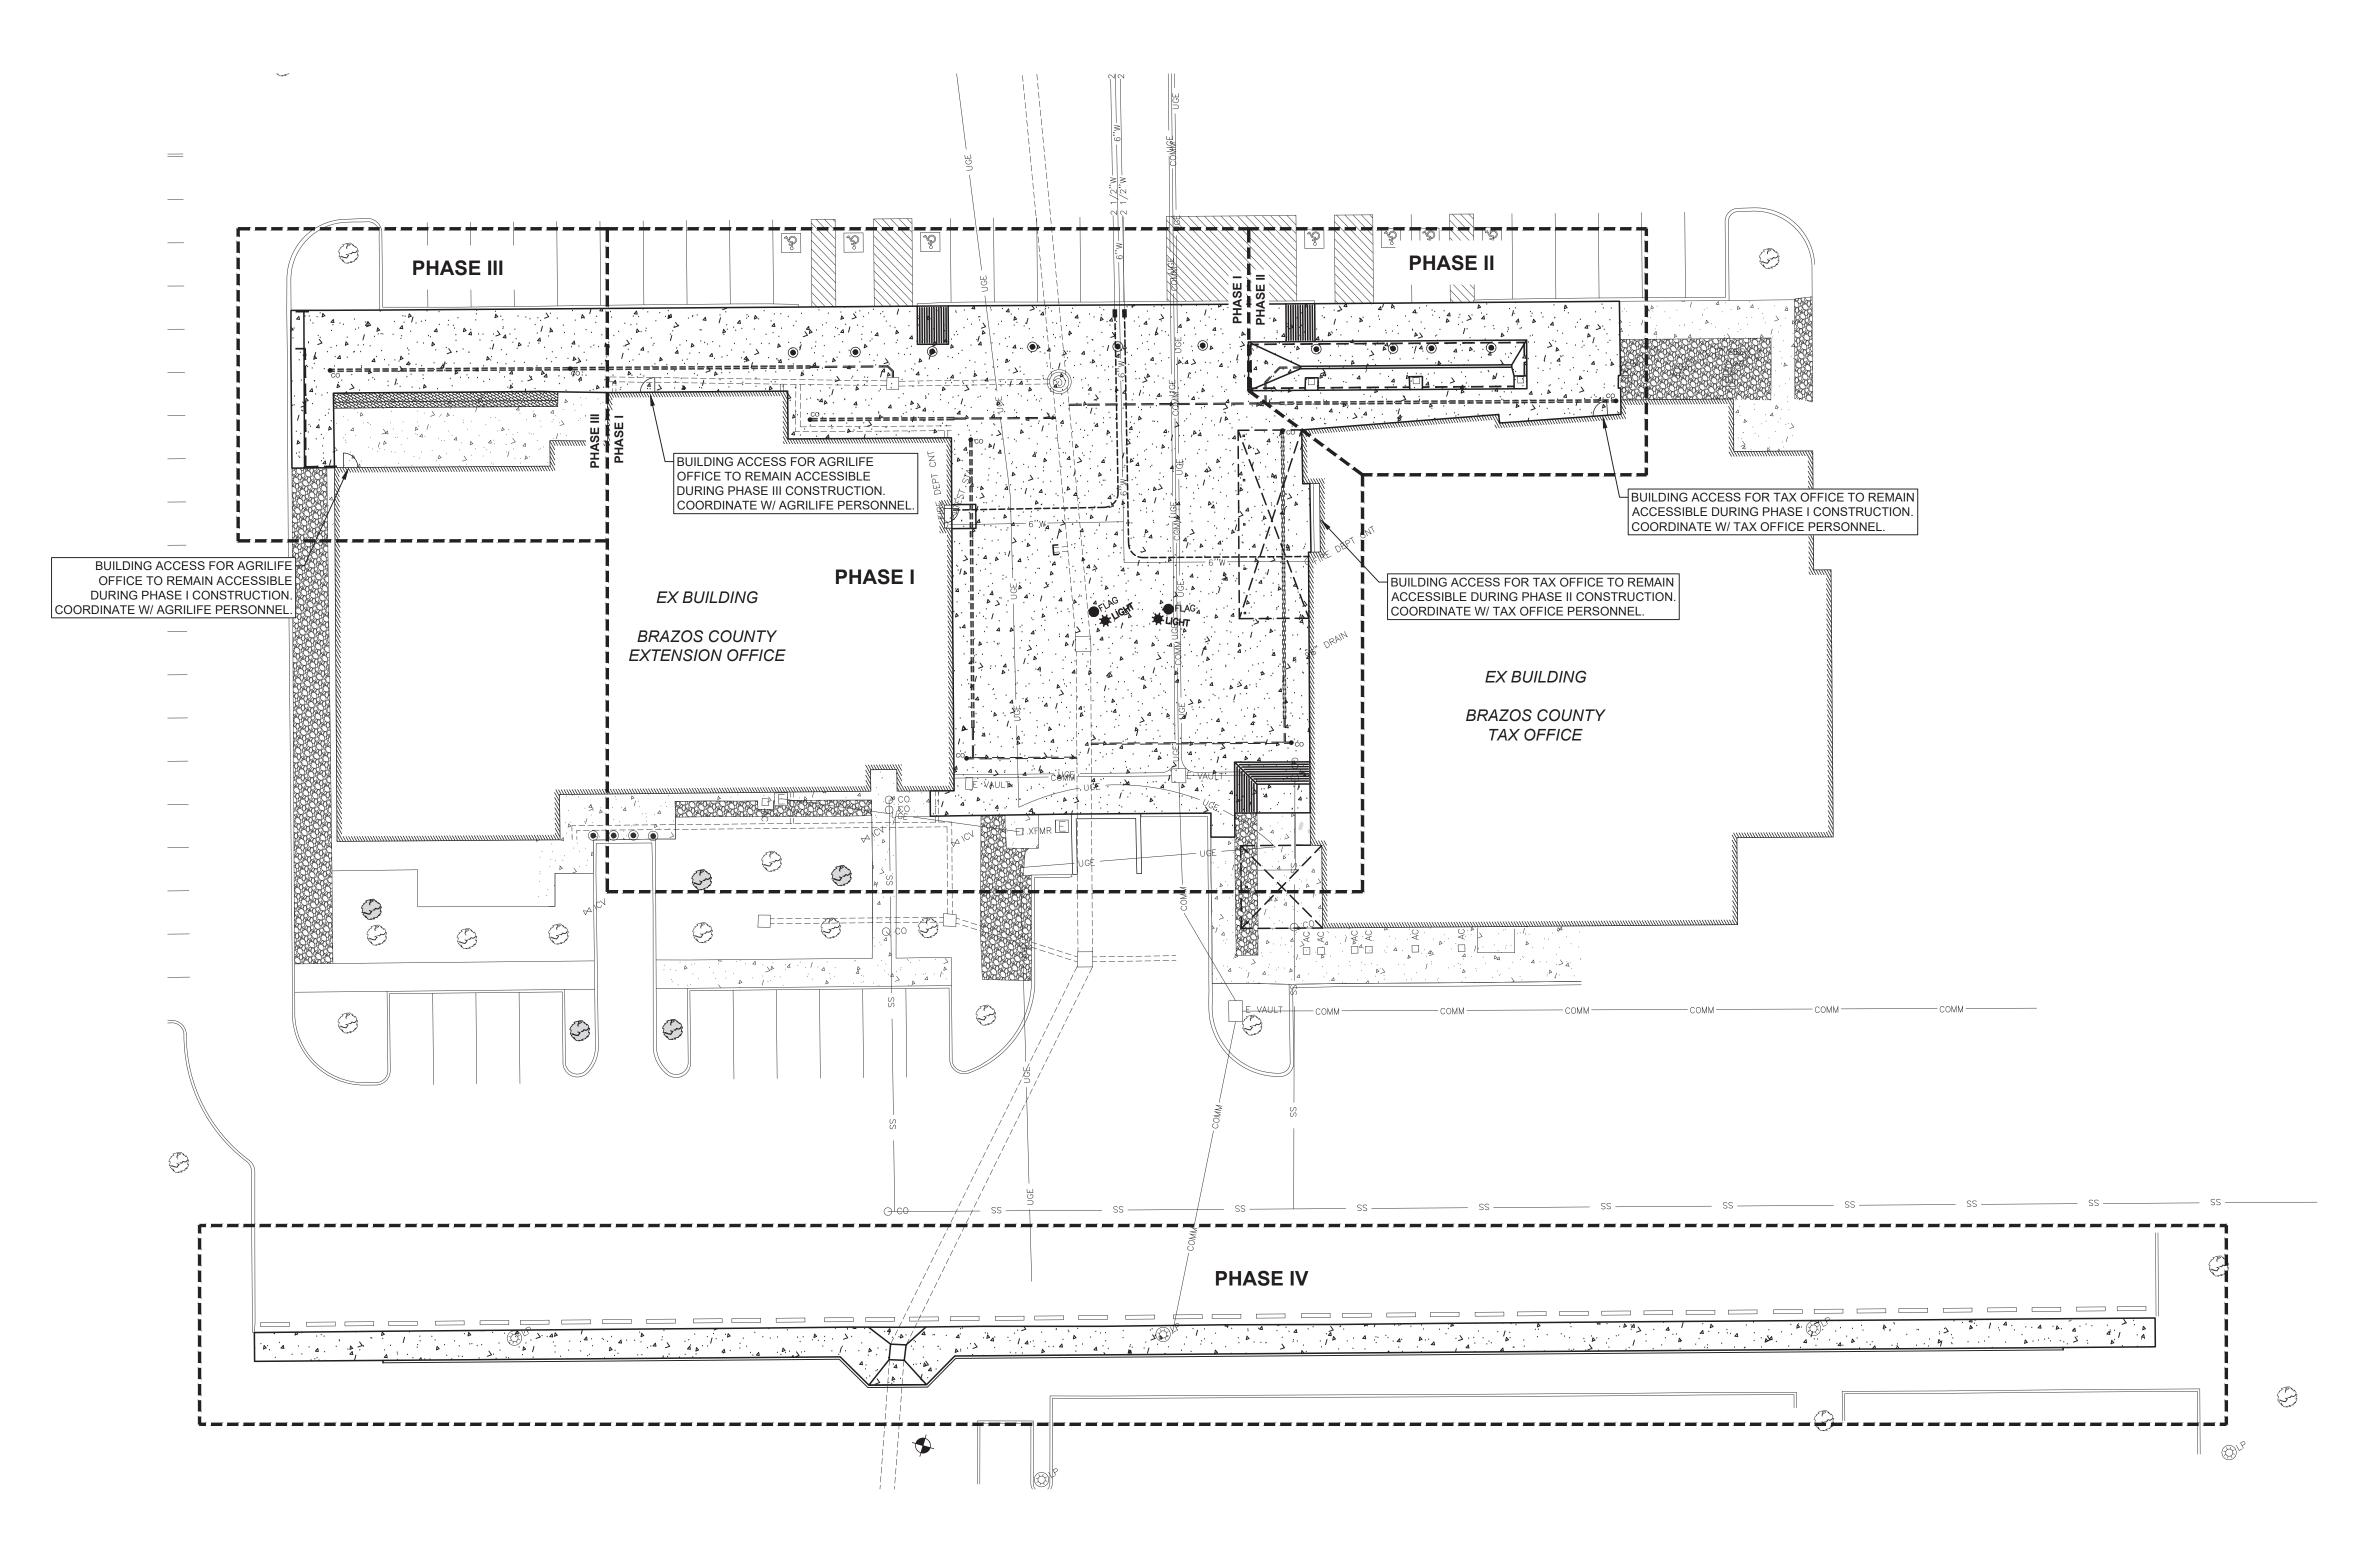
 $\mathbf{m}$ JOB NUMBER 619016 SHEET NO.

Paving Notes **General Notes** 

Vicinity Map

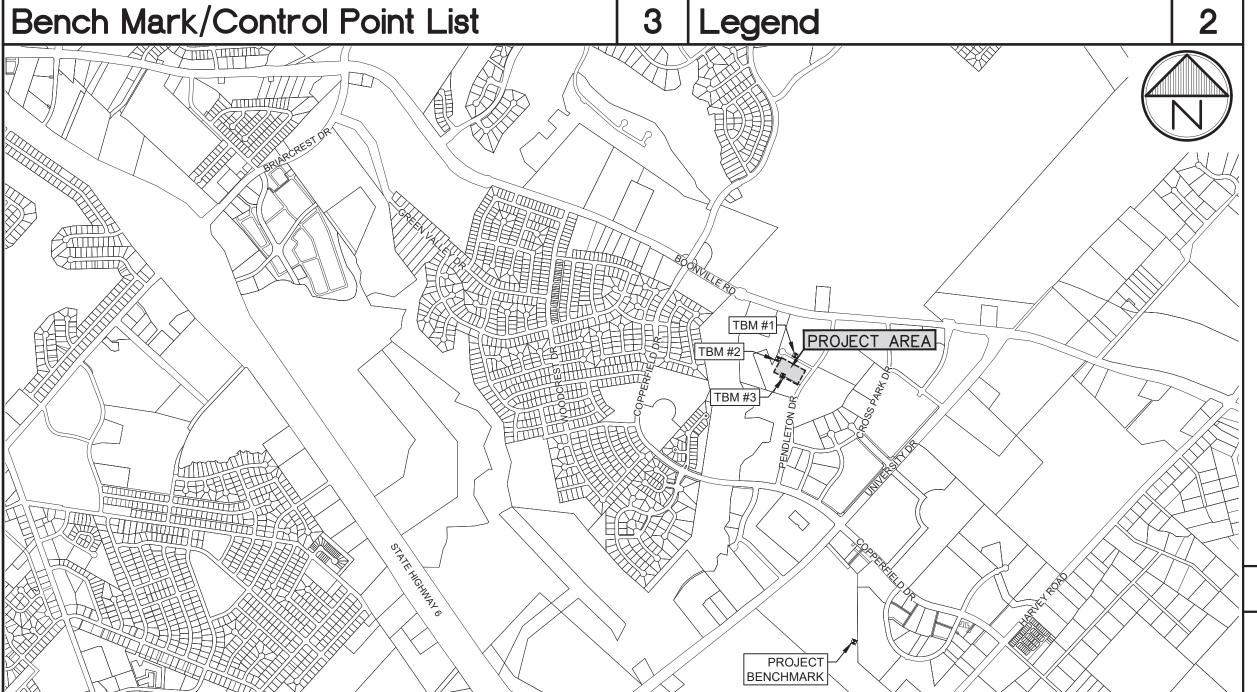N.T.S.



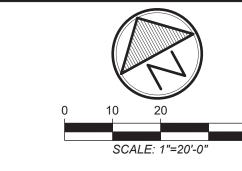

### NOTES:

- 1. CONTRACTOR SHALL PHASE NEW CONSTRUCTION SO THAT AT LEAST ONE ADA ACCESSIBLE ROUTE IS AVAILABLE INTO EACH BUILDING AT ALL TIMES DURING CONSTRUCTION.
- 2. CONTRACTOR SHALL INSTALL A TEMPORARY FENCE AROUND PERIMETER OF EACH PHASE TO PREVENT PEDESTRIANS FROM ENTERING THE CONSTRUCTION SITE.
- 3. CONTRACTOR SHALL COORDINATE WITH TAX OFFICE AND AGRILIFE OFFICE TO MAINTAIN ACCESS TO THEIR LOBBY AT ALL TIMES DURING CONSTRUCTION.
- 4. CONTRACTOR SHALL PROVIDE ADEQUATE SIGNAGE TO DIRECT PEDESTRIANS TO ACCESSIBLE DOOR DURING CONSTRUCTION.


T.B.P.E.L.S FIRM NO. F-413 T.B.A.E. FIRM NO. BR 351 T.B.P.E.L.S FIRM NO. 10110900 T.B.P.E.L.S FIRM NO. 10110901 ©2023 ALL RIGHTS RESERVED BY GOODWIN-LASITER, INC. UNAUTHORIZED USE OR REPRODUCTION IS PROHIBITED


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JOHN RUSK

Site ife & AgriLi hprover Texas Brazos ax

> JOB NUMBER 619016 SHEET NO.



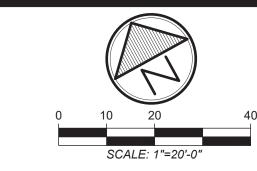

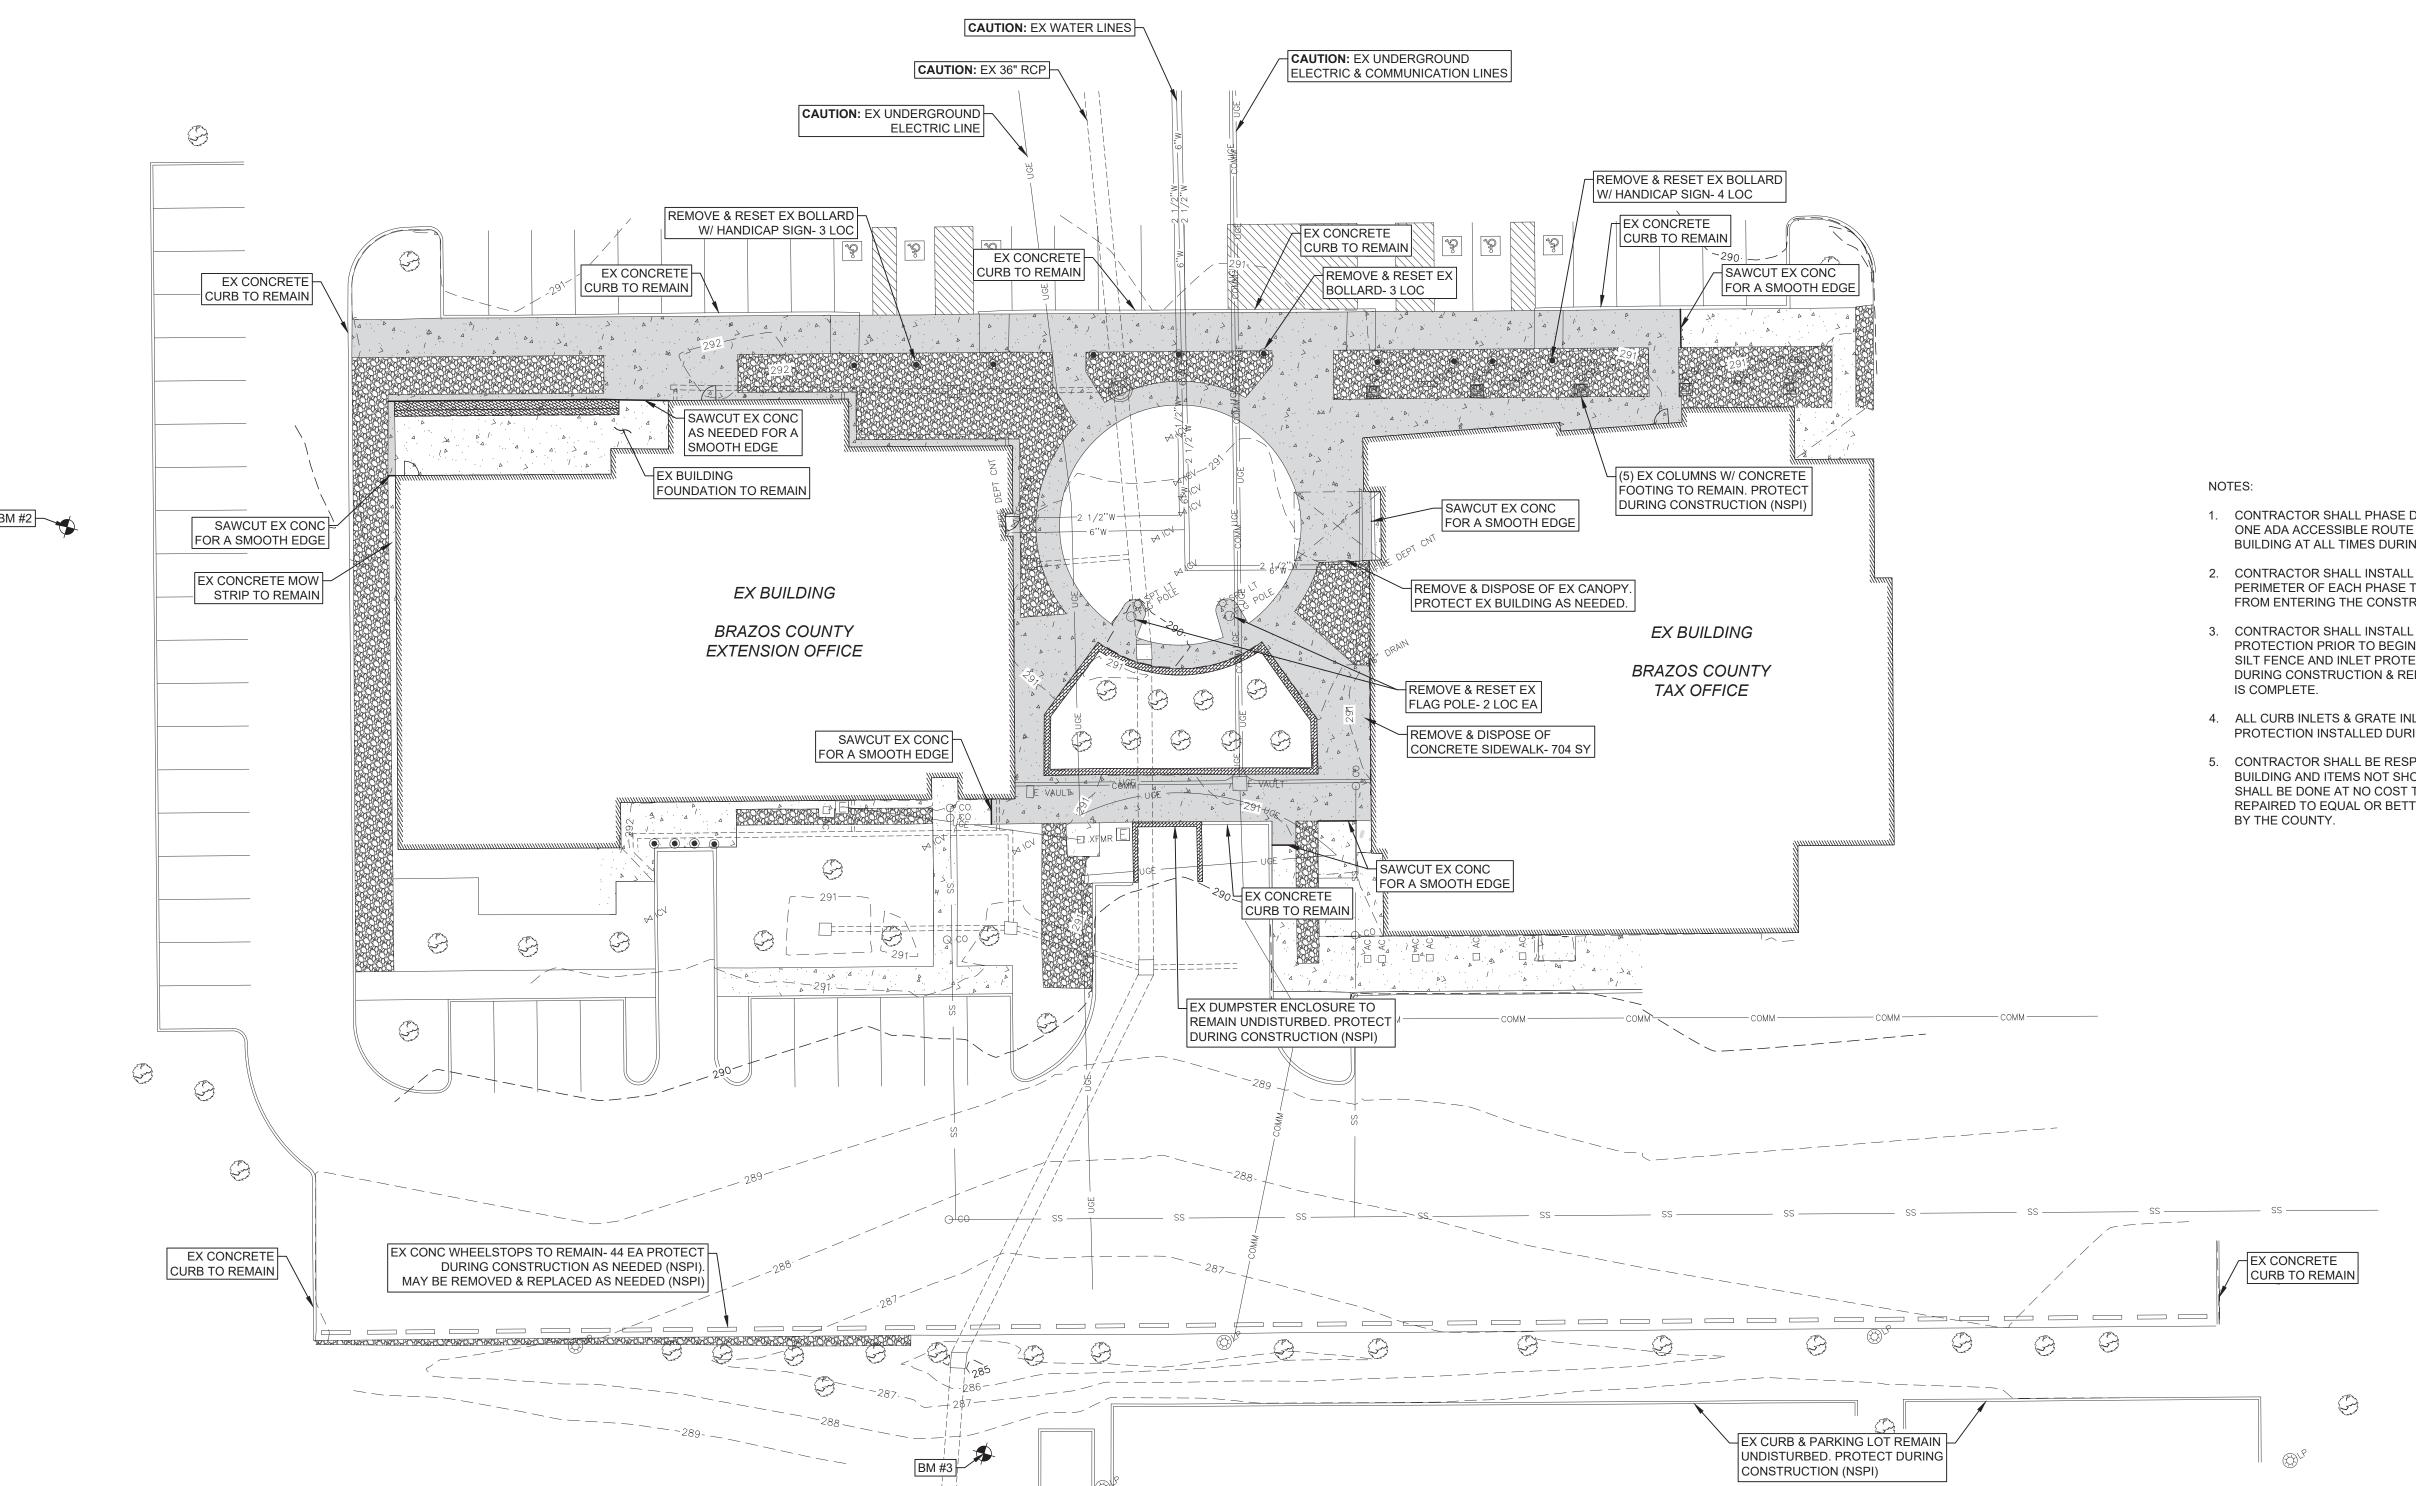LEGEND ASPHALT GRAVEL CONCRETE

- 1. CONTRACTOR SHALL PHASE DEMOLITION SO THAT AT LEAST ONE ADA ACCESSIBLE ROUTE IS AVAILABLE INTO EACH BUILDING AT ALL TIMES DURING CONSTRUCTION.
- 2. CONTRACTOR SHALL INSTALL A TEMPORARY FENCE AROUND PERIMETER OF EACH PHASE TO PREVENT PEDESTRIANS FROM ENTERING THE CONSTRUCTION SITE (NSPI).
- 3. CONTRACTOR SHALL INSTALL SILT FENCE AND INLET PROTECTION PRIOR TO BEGINNING ANY CONSTRUCTION. ALL SILT FENCE AND INLET PROTECTION SHALL BE MAINTAINED DURING CONSTRUCTION & REMOVED AFTER CONSTRUCTION
- 4. ALL CURB INLETS & GRATE INLETS ON SITE SHALL HAVE INLET PROTECTION INSTALLED DURING CONSTRUCTION.
- 5. CONTRACTOR SHALL BE RESPONSIBLE FOR ALL DAMAGES TO BUILDING AND ITEMS NOT SHOWN TO BE REMOVED. REPAIRS SHALL BE DONE AT NO COST TO THE COUNTY AND SHALL BE REPAIRED TO EQUAL OR BETTER CONDITION AS DETERMINED

JOHN RUSK 87884

T.B.P.E.L.S FIRM NO. F-413 T.B.A.E. FIRM NO. BR 351 T.B.P.E.L.S FIRM NO. 10110900


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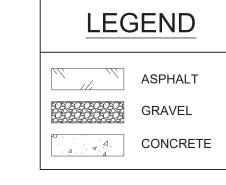
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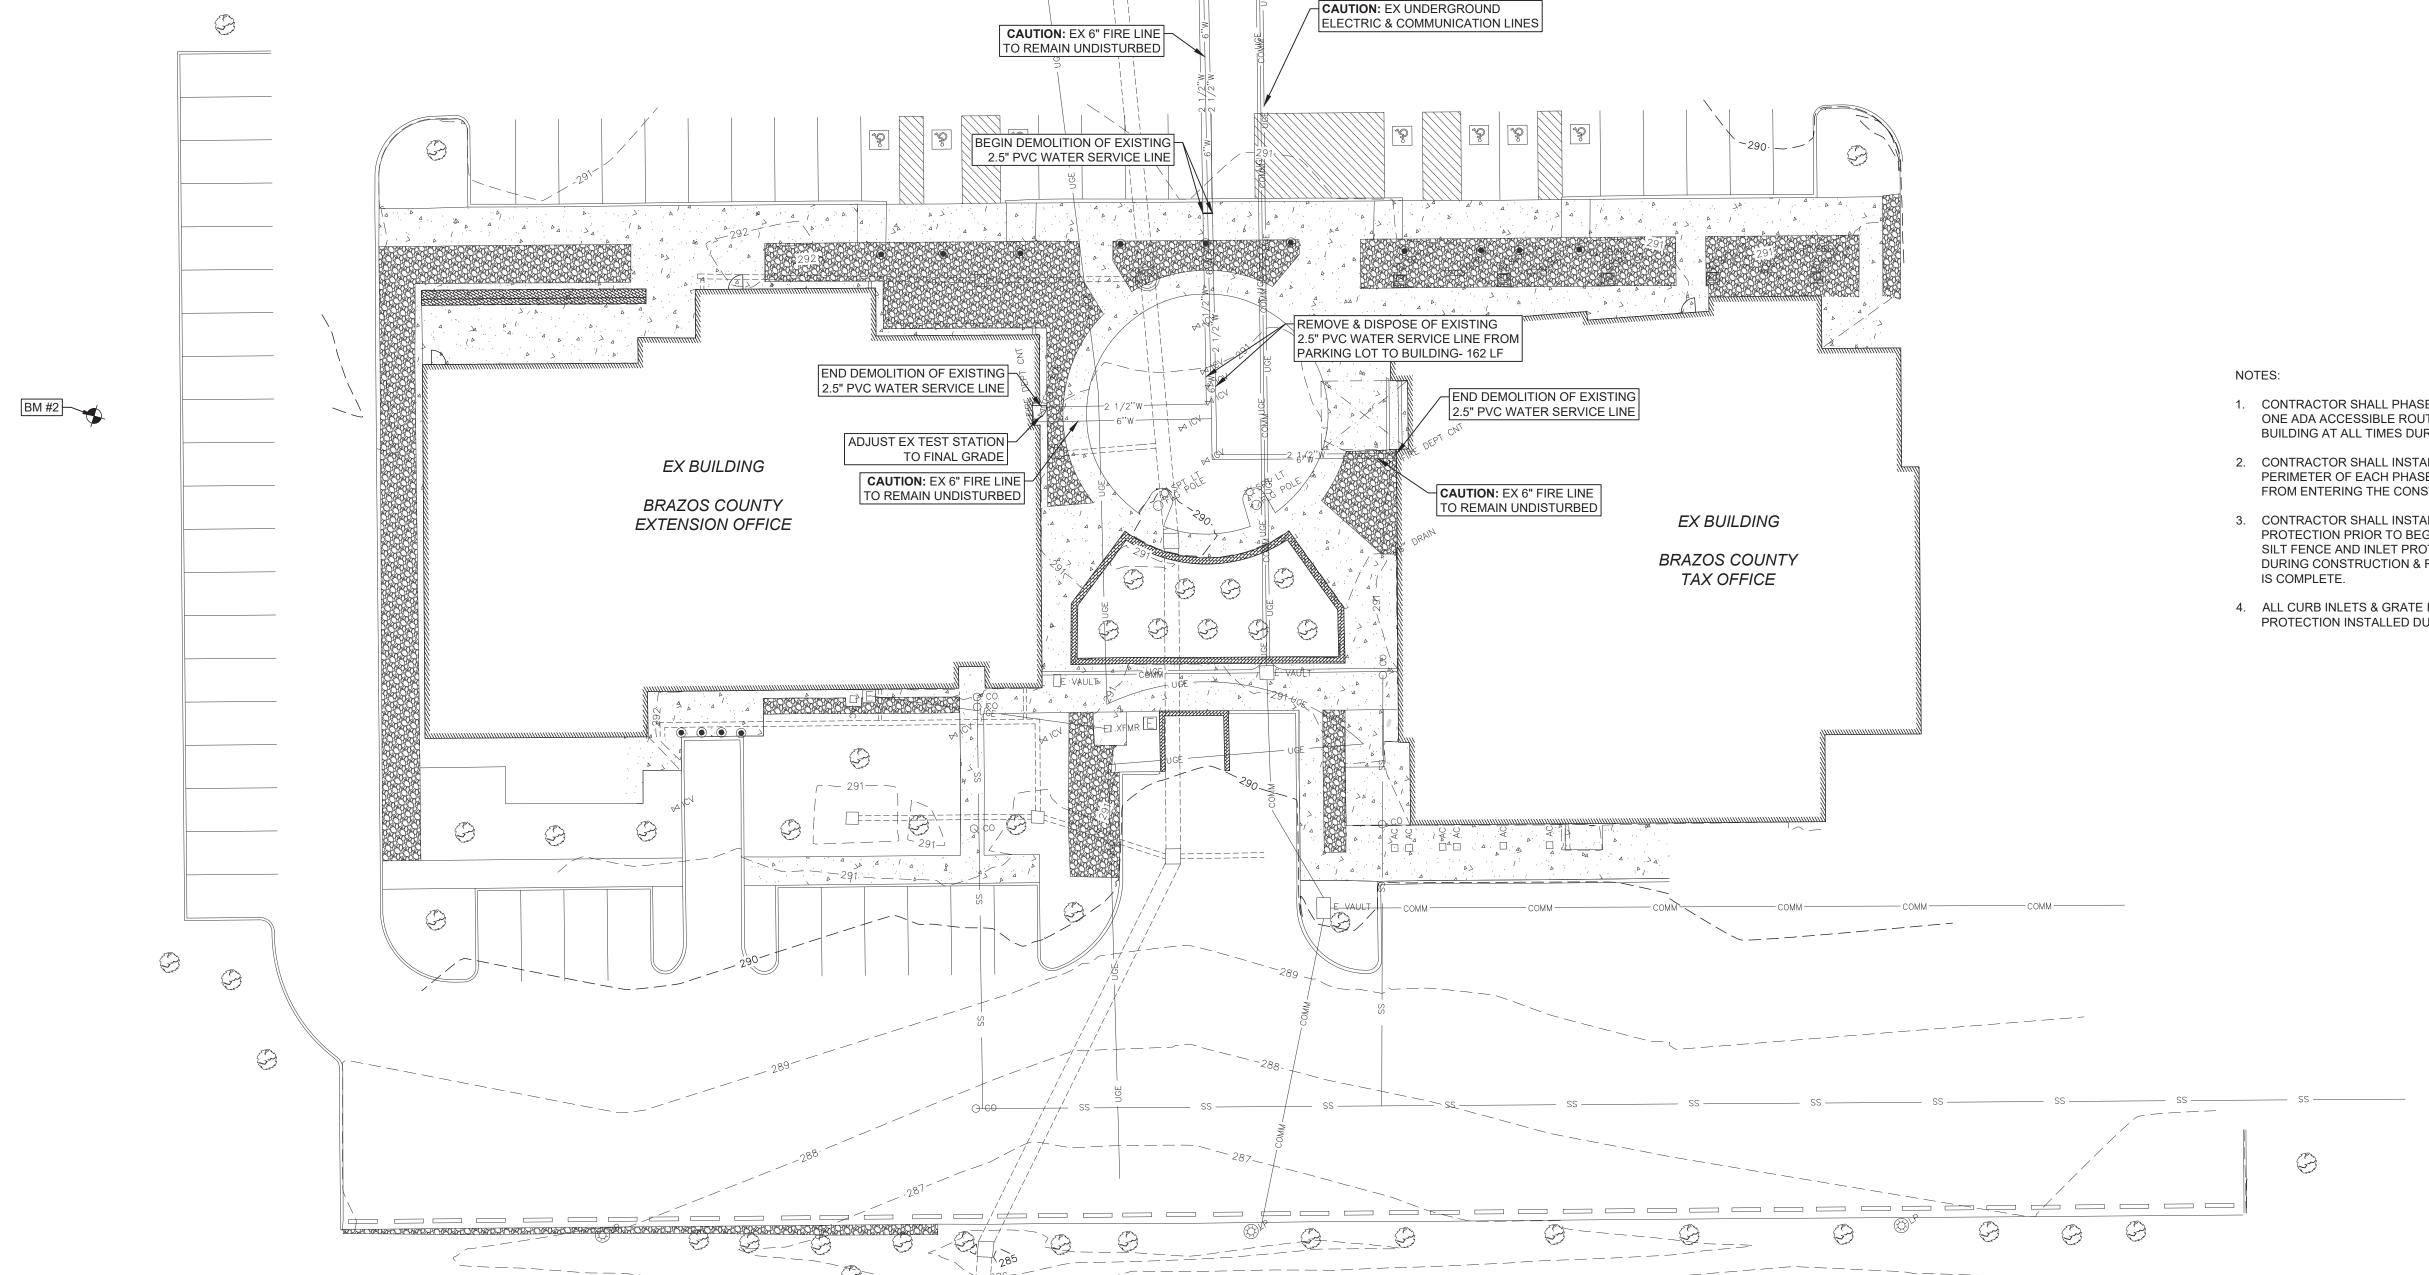
CONTRACT NO.

SHEET NO.

619016





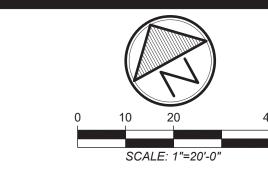

CAUTION: EX WATER LINES

- 1. CONTRACTOR SHALL PHASE DEMOLITION SO THAT AT LEAST ONE ADA ACCESSIBLE ROUTE IS AVAILABLE INTO EACH BUILDING AT ALL TIMES DURING CONSTRUCTION.
- 2. CONTRACTOR SHALL INSTALL A TEMPORARY FENCE AROUND PERIMETER OF EACH PHASE TO PREVENT PEDESTRIANS FROM ENTERING THE CONSTRUCTION SITE (NSPI).
- 3. CONTRACTOR SHALL INSTALL SILT FENCE AND INLET PROTECTION PRIOR TO BEGINNING ANY CONSTRUCTION. ALL SILT FENCE AND INLET PROTECTION SHALL BE MAINTAINED DURING CONSTRUCTION & REMOVED AFTER CONSTRUCTION
- 4. ALL CURB INLETS & GRATE INLETS ON SITE SHALL HAVE INLET PROTECTION INSTALLED DURING CONSTRUCTION.




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CONTRACT NO. 619016 SHEET NO.





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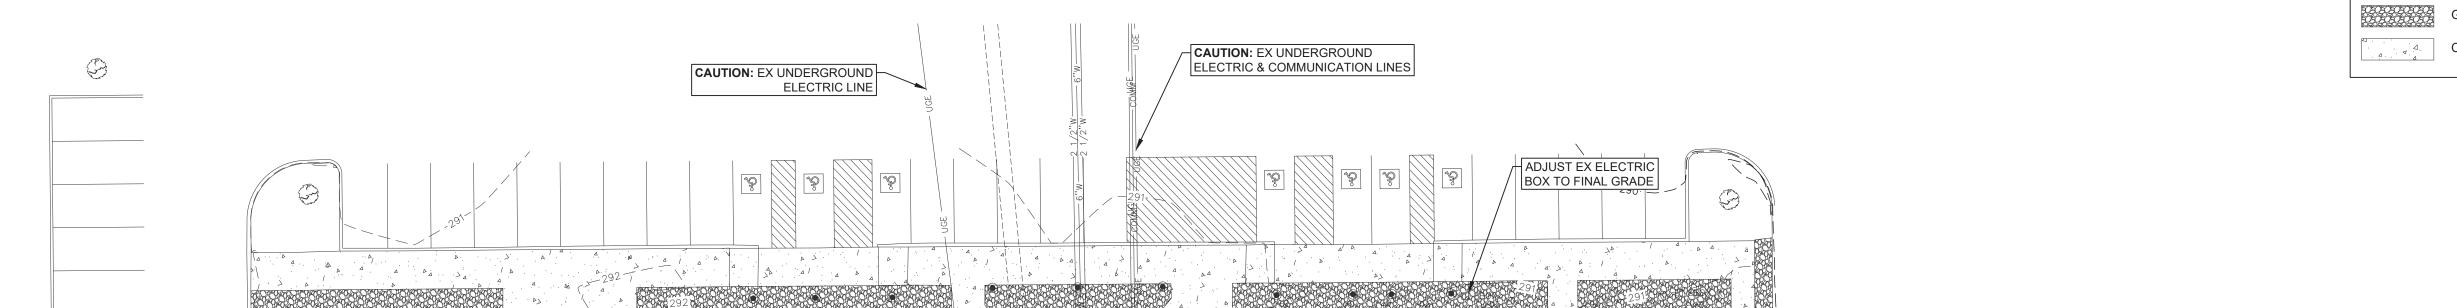




CONTRACT NO. 619016 SHEET NO.

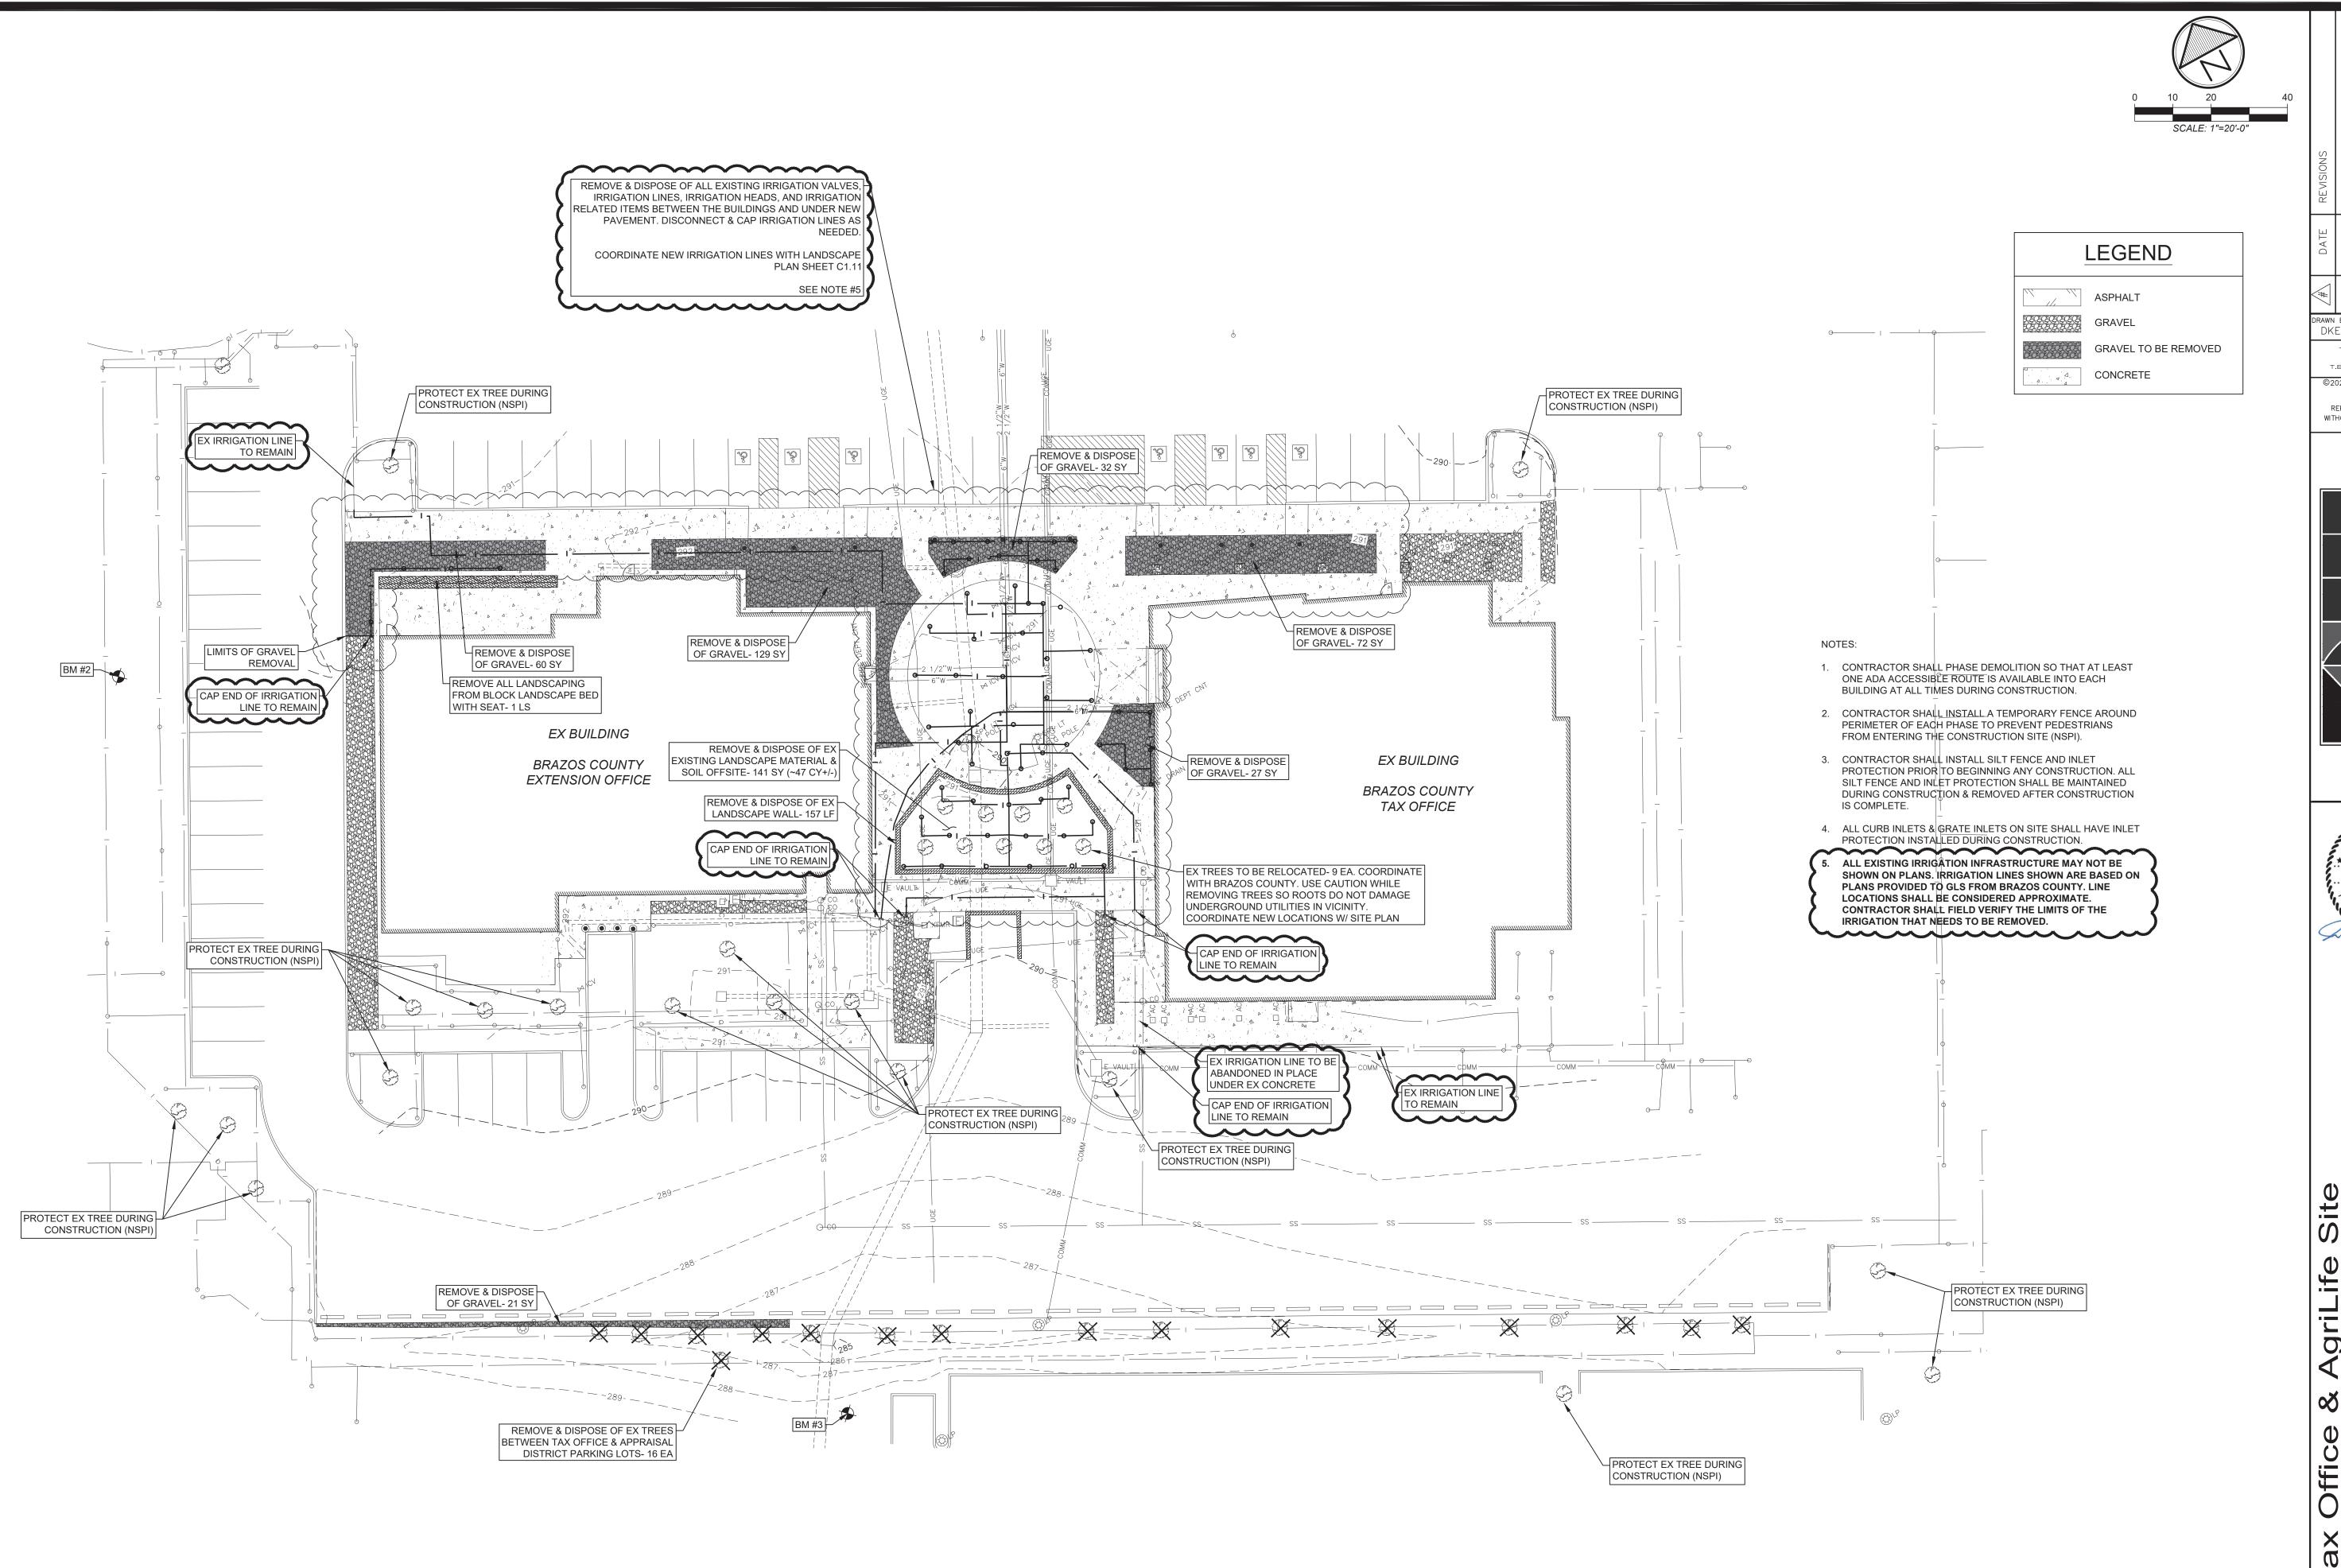

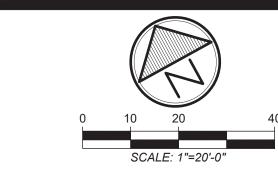

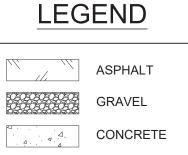

REMOVE & RESET EX LIGHT TO FINAL GRADE

ADJUST EX ELECTRIC VAULT TO FINAL GRADE

EX LIGHT POLE TO REMAIN UNDISTURBED. PROTECT DURING

CONSTRUCTION (NSPI)

BM #2

9

Existing Conditions and Demolition Plan - Electrical

EX LIGHT POLE TO REMAIN-UNDISTURBED. PROTECT DURING CONSTRUCTION (NSPI)

EX BUILDING

**BRAZOS COUNTY** 

EXTENSION OFFICE

REMOVE & RESET EX

LIGHT TO FINAL GRADE

ADJUST EX ELECTRIC VAULT TO FINAL GRADE

EX TRANSFORMER & PAD TO REMAIN UNDISTURBED. PROTECT DURING CONSTRUCTION (NSPI)


EX ELECTRIC PANELS TO REMAIN UNDISTURBED. PROTECT DURING CONSTRUCTION (NSPI)

### NOTES:

EX LIGHT POLE TO REMAIN UNDISTURBED. PROTECT DURING

CONSTRUCTION (NSPI)

- 1. CONTRACTOR SHALL PHASE DEMOLITION SO THAT AT LEAST ONE ADA ACCESSIBLE ROUTE IS AVAILABLE INTO EACH BUILDING AT ALL TIMES DURING CONSTRUCTION.
- 2. CONTRACTOR SHALL INSTALL A TEMPORARY FENCE AROUND PERIMETER OF EACH PHASE TO PREVENT PEDESTRIANS FROM ENTERING THE CONSTRUCTION SITE (NSPI).
- 3. CONTRACTOR SHALL INSTALL SILT FENCE AND INLET PROTECTION PRIOR TO BEGINNING ANY CONSTRUCTION. ALL SILT FENCE AND INLET PROTECTION SHALL BE MAINTAINED DURING CONSTRUCTION & REMOVED AFTER CONSTRUCTION IS COMPLETE.
- 4. ALL CURB INLETS & GRATE INLETS ON SITE SHALL HAVE INLET PROTECTION INSTALLED DURING CONSTRUCTION.
- 5. CONTRACTOR SHALL TEST ALL ELECTRICAL ITEMS ARE IN WORKING ORDER PRIOR TO INSTALLING NEW CONCRETE PAVEMENT.

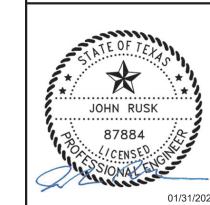



T.B.P.E.L.S FIRM NO. F-413

T.B.A.E. FIRM NO. BR 351 T.B.P.E.L.S FIRM NO. 10110900

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619016 SHEET NO.

CONTRACT NO.

NSPI = NO SEPARATE PAY ITEM


ADJUST EX LIGHTS TO


EX BUILDING

**BRAZOS COUNTY** 

TAX OFFICE

FINAL GRADE- 5 LOC

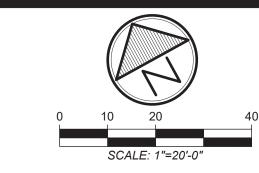

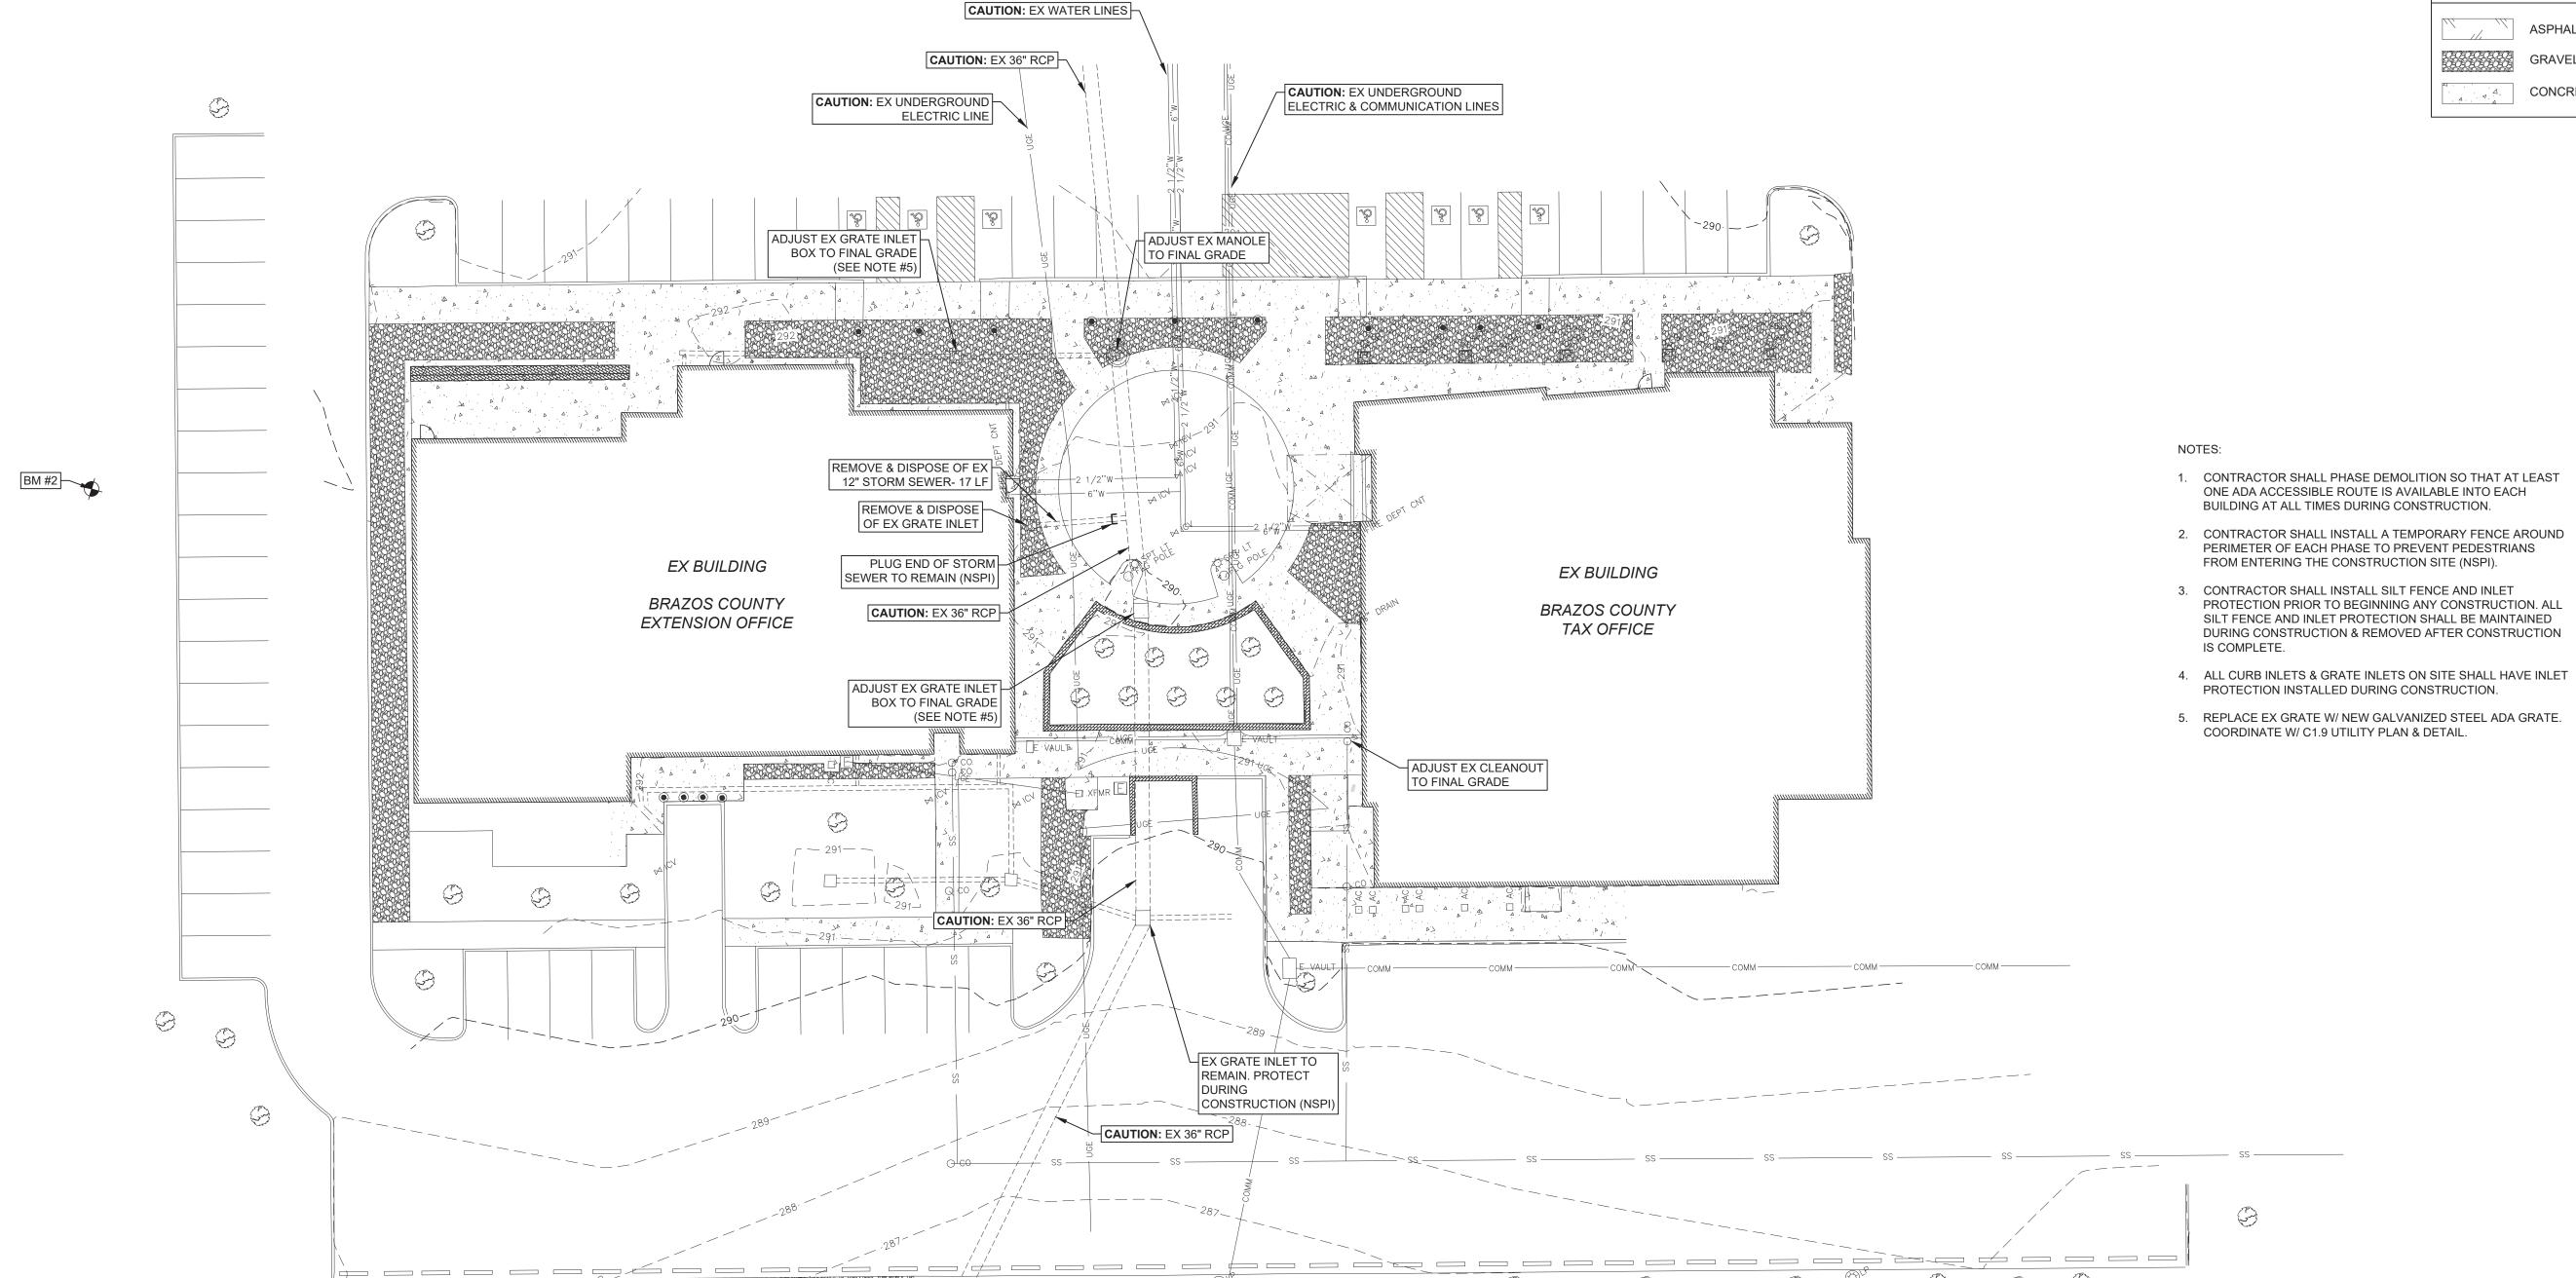

LEGEND

ASPHALT


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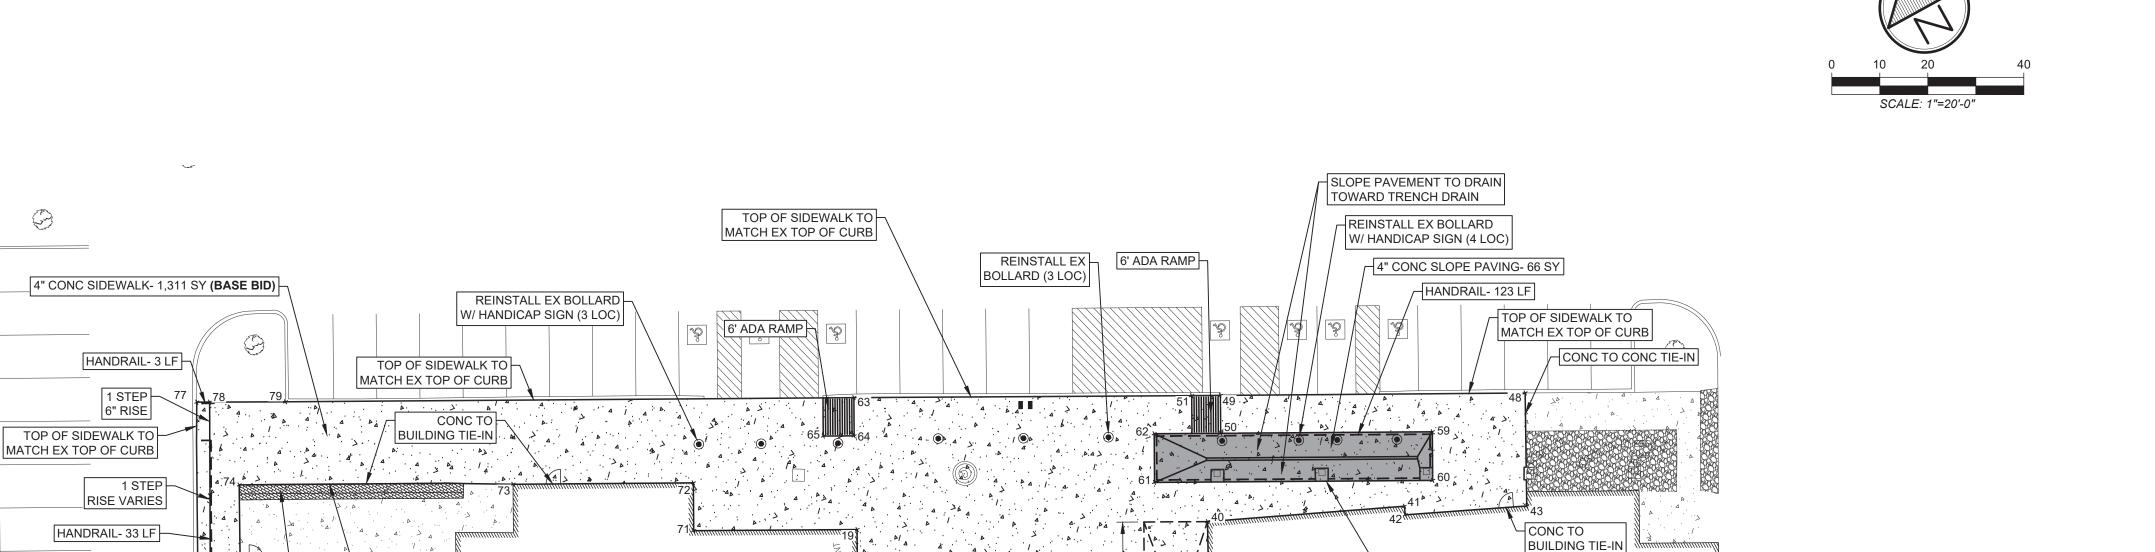
T.B.P.E.L.S FIRM NO. F-413

JOHN RUSK 87884



CONTRACT NO. 619016 SHEET NO.



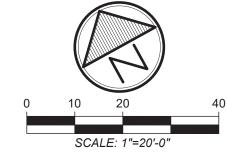

TOP OF SIDEWALK TO MATCH EX TOP OF CURB

CONC TO CONC TIE-IN

FOR CANOPY DETAILS.

EX GRATE INLET TO REMAIN PROTECT DURING CONSTRUCTION

EX 36" RCP FL<sub>IN</sub> (NE)=280.35 EX 36" RCP FL<sub>OUT</sub> (SW)=279.93 E VAUL

NEW ARCHITECTURAL CANOPY. REFER TO SPEC SECTION 10530

CONCRETE FLUME- 298 SY

WRAP NEW CONCRETE AROUND

EX BUILDING

**BRAZOS COUNTY** 

TAX OFFICE

EX PARKING LOT

BRAZOS COUNTY APPRAISAL OFFICE

THE BASE OF EX COLUMNS W/

CONC BASE- 3 LOC (NSPI)

NEW ARCHITECTURAL CANOPY. REFER TO SPEC SECTION 10530

FOR CANOPY DETAILS.

CONC TO CONC TIE-IN

HIGH CURB- 355 LF 6" MIN-15" MAX (RE: DETAIL)

	Point Table		
Point #	Raw Description	Northing	Easting
1	EDGE OF PAVEMENT	10225795.9616	3565180.6791
2	EDGE OF PAVEMENT	10225791.3288	3565178.1590
3	EDGE OF PAVEMENT	10225763.6622	3565229.6517
4	EDGE OF PAVEMENT	10225759.2803	3565227.2350
5	EDGE OF PAVEMENT	10225756.8726	3565231.6006
6	RAMP	10225761.2772	3565234.0062
7	RAMP	10225759.0395	3565238.0527
8	EDGE OF PAVEMENT	10225753.7326	3565247.7811
9	RAMP	10225764.3183	3565240.9440
10	RAMP	10225759.0049	3565250.6453
11	RAMP	10225763.0731	3565252.8553
15	EDGE OF PAVEMENT	10225793.5844	3565185.0491
19	EDGE OF PAVEMENT	10225858.2385	3565220.0601
38	EDGE OF PAVEMENT	10225801.4437	3565273.6997
39	EDGE OF PAVEMENT	10225814.5105	3565279.5443
40	EDGE OF PAVEMENT	10225824.4389	3565284.7726
41	EDGE OF PAVEMENT	10225807.4227	3565322.2541
42	EDGE OF PAVEMENT	10225805.7804	3565321.5377
43	EDGE OF PAVEMENT	10225795.1699	3565344.5797
48	EDGE OF PAVEMENT	10225815.9427	3565355.6682
49	RAMP	10225846.1483	3565299.8335
50	RAMP	10225839.2215	3565296.0761
51	RAMP	10225849.0015	3565294.5641
59	PAVEMENT	10225818.2014	3565334.8270

PAVEMENT

73	PAVEMENT	10225901.1299	3565161.8400
74	PAVEMENT	10225928.5567	3565111.8243
75	STEP	10225917.8229	3565099.0209
76	EDGE OF PAVEMENT	10225919.0507	3565096.7235
77	EDGE OF PAVEMENT	10225947.9238	3565112.4246
78	STEP	10225946.6402	3565114.7729
79	EDGE OF PAVEMENT	10225939.0527	3565128.6537
80	EDGE OF PAVEMENT	10225765.1496	3565002.8930
81	EDGE OF PAVEMENT	10225759.8738	3565000.0354
82	EDGE OF PAVEMENT	10225914.8852	3565104.5177
86	HIGH CURB	10225746.6962	3565023.3150
87	HIGH CURB	10225689.8693	3565128.2335
88	HIGH CURB	10225701.4281	3565106.8927
89	HIGH CURB	10225693.3931	3565109.2808
90	HIGH CURB	10225687.4784	3565120.1955
91	HIGH CURB	10225579.9961	3565331.0902
92	EDGE OF PAVEMENT	10225571.2874	3565348.2187
93	EDGE OF PAVEMENT	10225576.5633	3565351.0763

Point Table

Northing

Easting

10225836.9133 | 3565279.0504 |

10225845.8325 3565283.8885

10225882.6245 | 3565232.7433

10225875.6330 | 3565228.9509

10225878.7029 | 3565223.2914

10225874.4804 3565190.1509

10225883.2381 3565194.8906

| Point # | Raw Description

62

63

64

65

71

72

PAVEMENT

PAVEMENT

RAMP

PAVEMENT

PAVEMENT

Point Table			
nt #	Raw Description	Northing	Easting
99	EXISTING GRATE INLET	10225806.6740	3565221.2463
00	EXISTING GRATE INLET	10225808.0758	3565225.4987
01	LIGHT	10225809.4040	3565229.7330
02	FLAGPOLE	10225812.1647	3565228.5589
03	LIGHT	10225804.4190	3565239.5250
04	FLAGPOLE	10225805.1376	3565242.4376
	·	· ·	· ·

10225809.2893 | 3565329.9927 |


T.B.P.E.L.S FIRM NO. F-413 T.B.A.E. FIRM NO. BR 351

T.B.P.E.L.S FIRM NO. 10110900

T.B.P.E.L.S FIRM NO. 1011090

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Site

AgriL

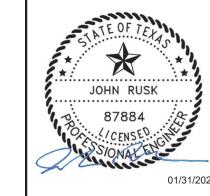NOTES:

- 1. CONTRACTOR SHALL PHASE NEW CONSTRUCTION SO THAT AT LEAST ONE ADA ACCESSIBLE ROUTE IS AVAILABLE INTO EACH BUILDING AT ALL TIMES DURING CONSTRUCTION.
- 2. CONTRACTOR SHALL INSTALL A TEMPORARY FENCE AROUND PERIMETER OF EACH PHASE TO PREVENT PEDESTRIANS FROM ENTERING THE CONSTRUCTION SITE (NSPI).

 
 CUT/FILL ANALYSIS

 CUT
 FILL
 NET FILL

 67.16 CY
 157.46 CY
 90.31 CY
 THE CUT/FILL NUMBERS ABOVE ARE BASED ON A CUT:FILL RATIO OF 1:1 AND ARE TO THE TOP OF FINISHED PAVEMENT

 BASE BID CUT/FILL ANALYSIS

 FILL
 4" CONC PVMT
 NET CUT

 90.31 CY
 -145.52 CY
 55.21 CY

THE FILL NUMBER ABOVE IS BASED ON A CUT:FILL RATIO OF 1:1 AND IS TO THE TOP OF FINISHED PAVEMENT. THE NET CUT NUMBER ABOVE IS TO THE BOTTOM OF PAVEMENT SECTION.

NSPI = NO SEPARATE PAY ITEM

JOB NUMBER 619016

SHEET NO.

\_\_BM# 2

INSTALL EXPANSION JOINT

USE BLOCKS TO CAP OFF LANDSCAPE AREA

EX BUILDING

BRAZOS COUNTY

EXTENSION OFFICE

FOUNDATION (NSPI)

ON EXISTING BLOCK LANDSCAPE BED W/

SEAT. CONTRACTOR TO ENSURE THAT THE

FINAL BLOCK WALL IS PROPERLY SEALED.

EX CONC WHEELSTOPS TO REMAIN- 44 EA PROTECT

MAY BE REMOVED & REPLACED AS NEEDED (NSPI)

DURING CONSTRUCTION AS NEEDED (NSPI).

ALONG EDGE OF BUILDING

1-6" STEP FROM LANDING

CONC TO CONC TIE-IN

TO BUILDING FF


RAISED 5'x5' LANDING


1-6" STEP AROUND

ENTIRE LANDING


REINSTALL FLAG

POLE- 2 LOC

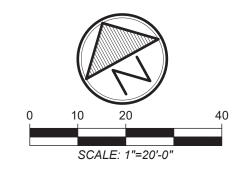

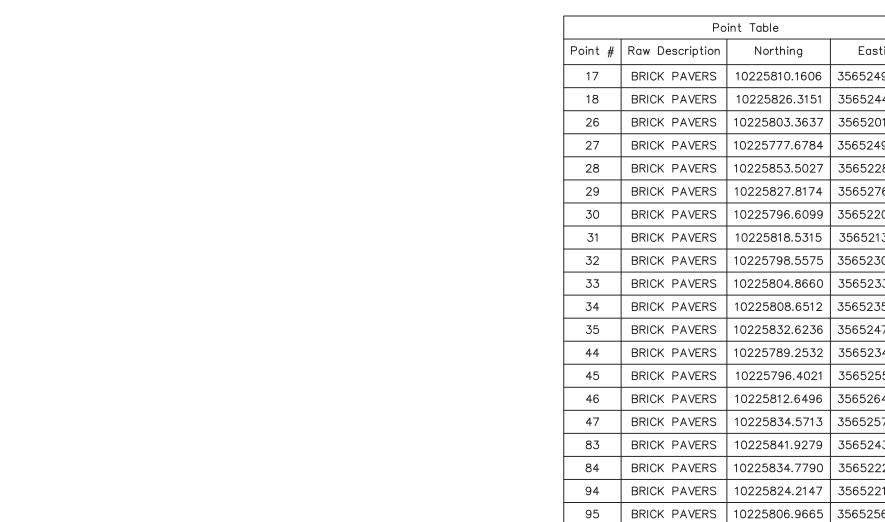

Point Table			
Point #	Raw Description	Northing	Easting
17	BRICK PAVERS	10225810.1606	3565249.7363
18	BRICK PAVERS	10225826.3151	3565244.4418
26	BRICK PAVERS	10225803.3637	3565201.7056
27	BRICK PAVERS	10225777.6784	3565249.2057
28	BRICK PAVERS	10225853.5027	3565228.8179
29	BRICK PAVERS	10225827.8174	3565276.3180
30	BRICK PAVERS	10225796.6099	3565220.5026
31	BRICK PAVERS	10225818.5315	3565213.3179
32	BRICK PAVERS	10225798.5575	3565230.3877
33	BRICK PAVERS	10225804.8660	3565233.5818
34	BRICK PAVERS	10225808.6512	3565235.4982
35	BRICK PAVERS	10225832.6236	3565247.6359
44	BRICK PAVERS	10225789.2532	3565234.1073
45	BRICK PAVERS	10225796.4021	3565255.9199
46	BRICK PAVERS	10225812.6496	3565264.7056
47	BRICK PAVERS	10225834.5713	3565257.5209
83	BRICK PAVERS	10225841.9279	3565243.9162
84	BRICK PAVERS	10225834.7790	3565222.1036
94	BRICK PAVERS	10225824.2147	3565221.9787
95	BRICK PAVERS	10225806.9665	3565256.0448
97	BRICK PAVERS	10225821.0206	3565228.2873
98	BRICK PAVERS	10225822.5300	3565242.5253

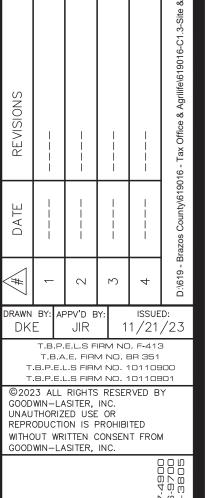

JOHN RUSK



Site

AgriLife Tprovemer

NOTES:

- 1. CONTRACTOR SHALL PHASE NEW CONSTRUCTION SO THAT AT LEAST ONE ADA ACCESSIBLE ROUTE IS AVAILABLE INTO EACH BUILDING AT ALL TIMES DURING CONSTRUCTION.
- 2. CONTRACTOR SHALL INSTALL A TEMPORARY FENCE AROUND PERIMETER OF EACH PHASE TO PREVENT PEDESTRIANS FROM ENTERING THE CONSTRUCTION SITE (NSPI).

CUT/FILL ANALYSIS
CUT FILL NET FILL
67.16 CY 157.46 CY 90.31 CY THE CUT/FILL NUMBERS ABOVE ARE BASED ON A CUT:FILL RATIO OF 1:1 AND ARE TO THE TOP OF FINISHED PAVEMENT

BRICK PAVERS (HERRINGBONE

1312 SF (ALT. BID)

798 SF (ALT. BID)

PATTERN) INCLUDING CONCRETE-

BRICK PAVERS (RUNNER BOND PATTERN) INCLUDING CONCRETE- EX BUILDING

**BRAZOS COUNTY** 

TAX OFFICE

| ALTERNATE BID CUT/FILL ANALYSIS | FILL | 7-3/8" PAVER SECTION | 4" CONC PVMT | NET CUT | 90.31 CY | -48.03 CY | -119.55 CY | 77.27 CY | THE FILL NUMBER ABOVE IS BASED ON A CUT: FILL RATIO OF 1:1 AND IS TO THE TOP OF FINISHED PAVEMENT. THE NET CUT NUMBER ABOVE IS TO THE BOTTOM OF PAVEMENT SECTION.

NSPI = NO SEPARATE PAY ITEM

Site Plan - Alt. Bid

\_\_BM # 2

4" CONC SIDEWALK- 1,077 SY (ALT. BID)

EX BUILDING


**BRAZOS COUNTY** 

EXTENSION OFFICE


JOB NUMBER 619016

SHEET NO.

1"=20'-0"

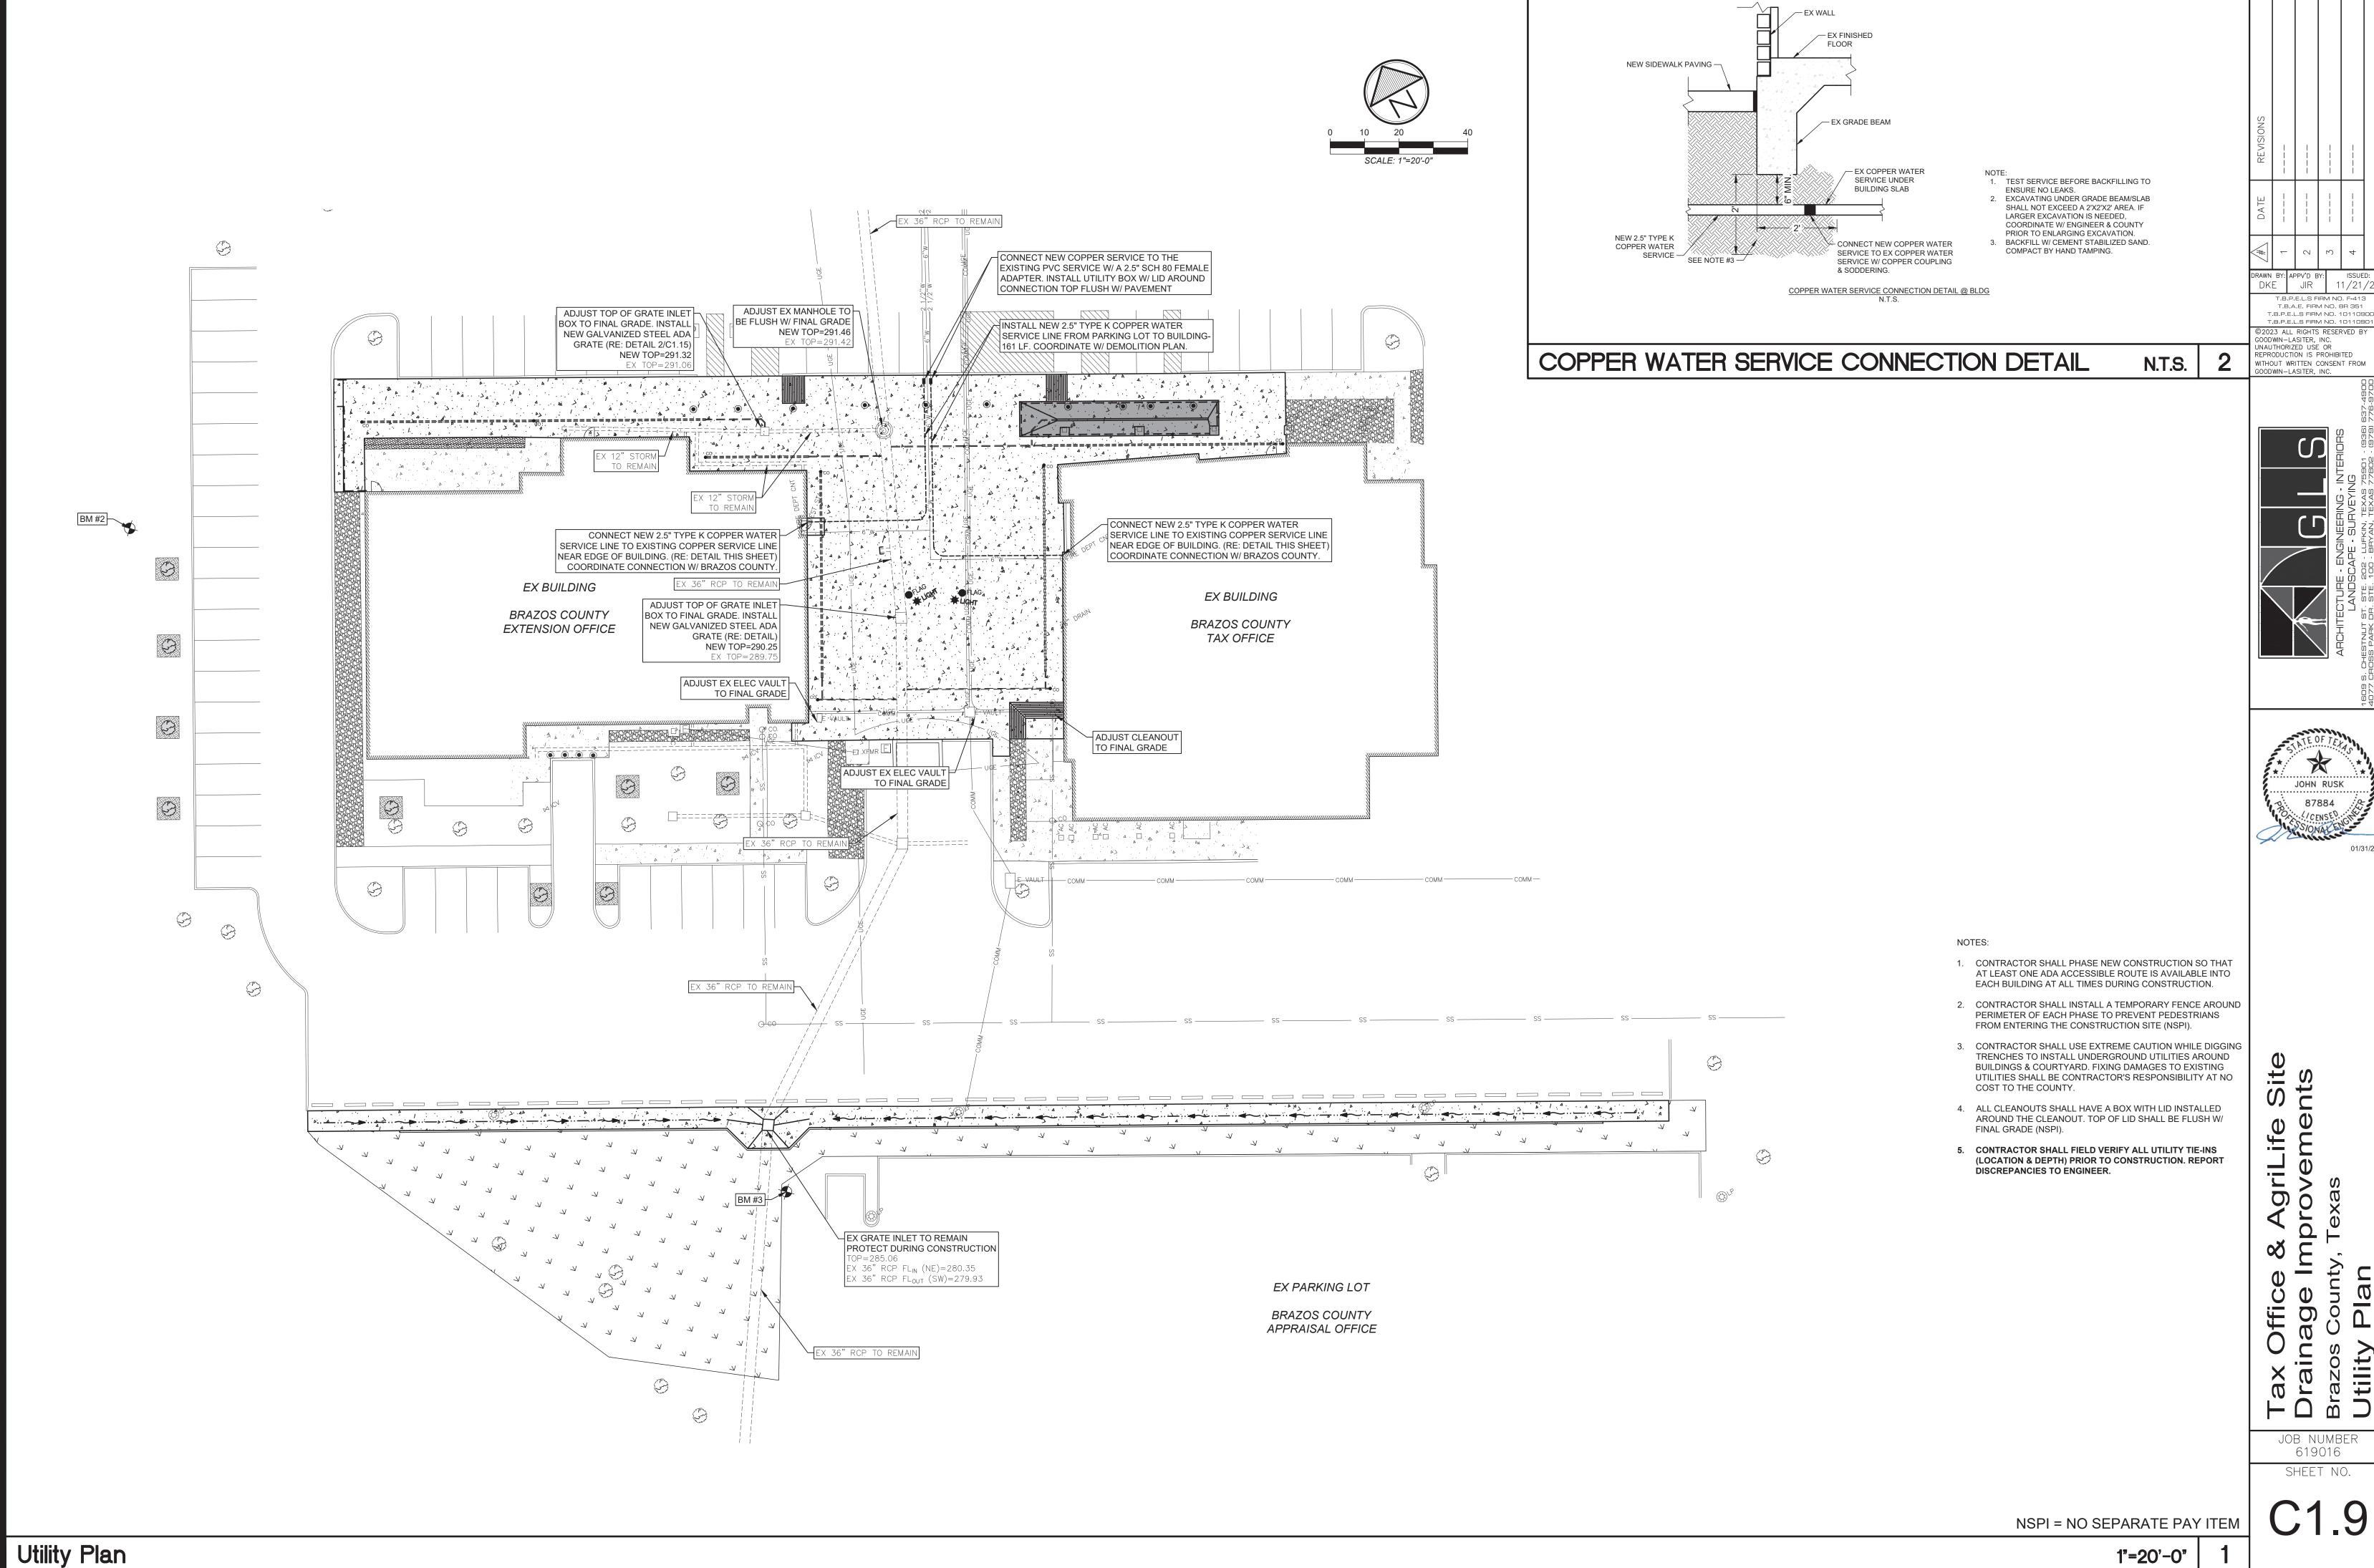


1"=20'-0"

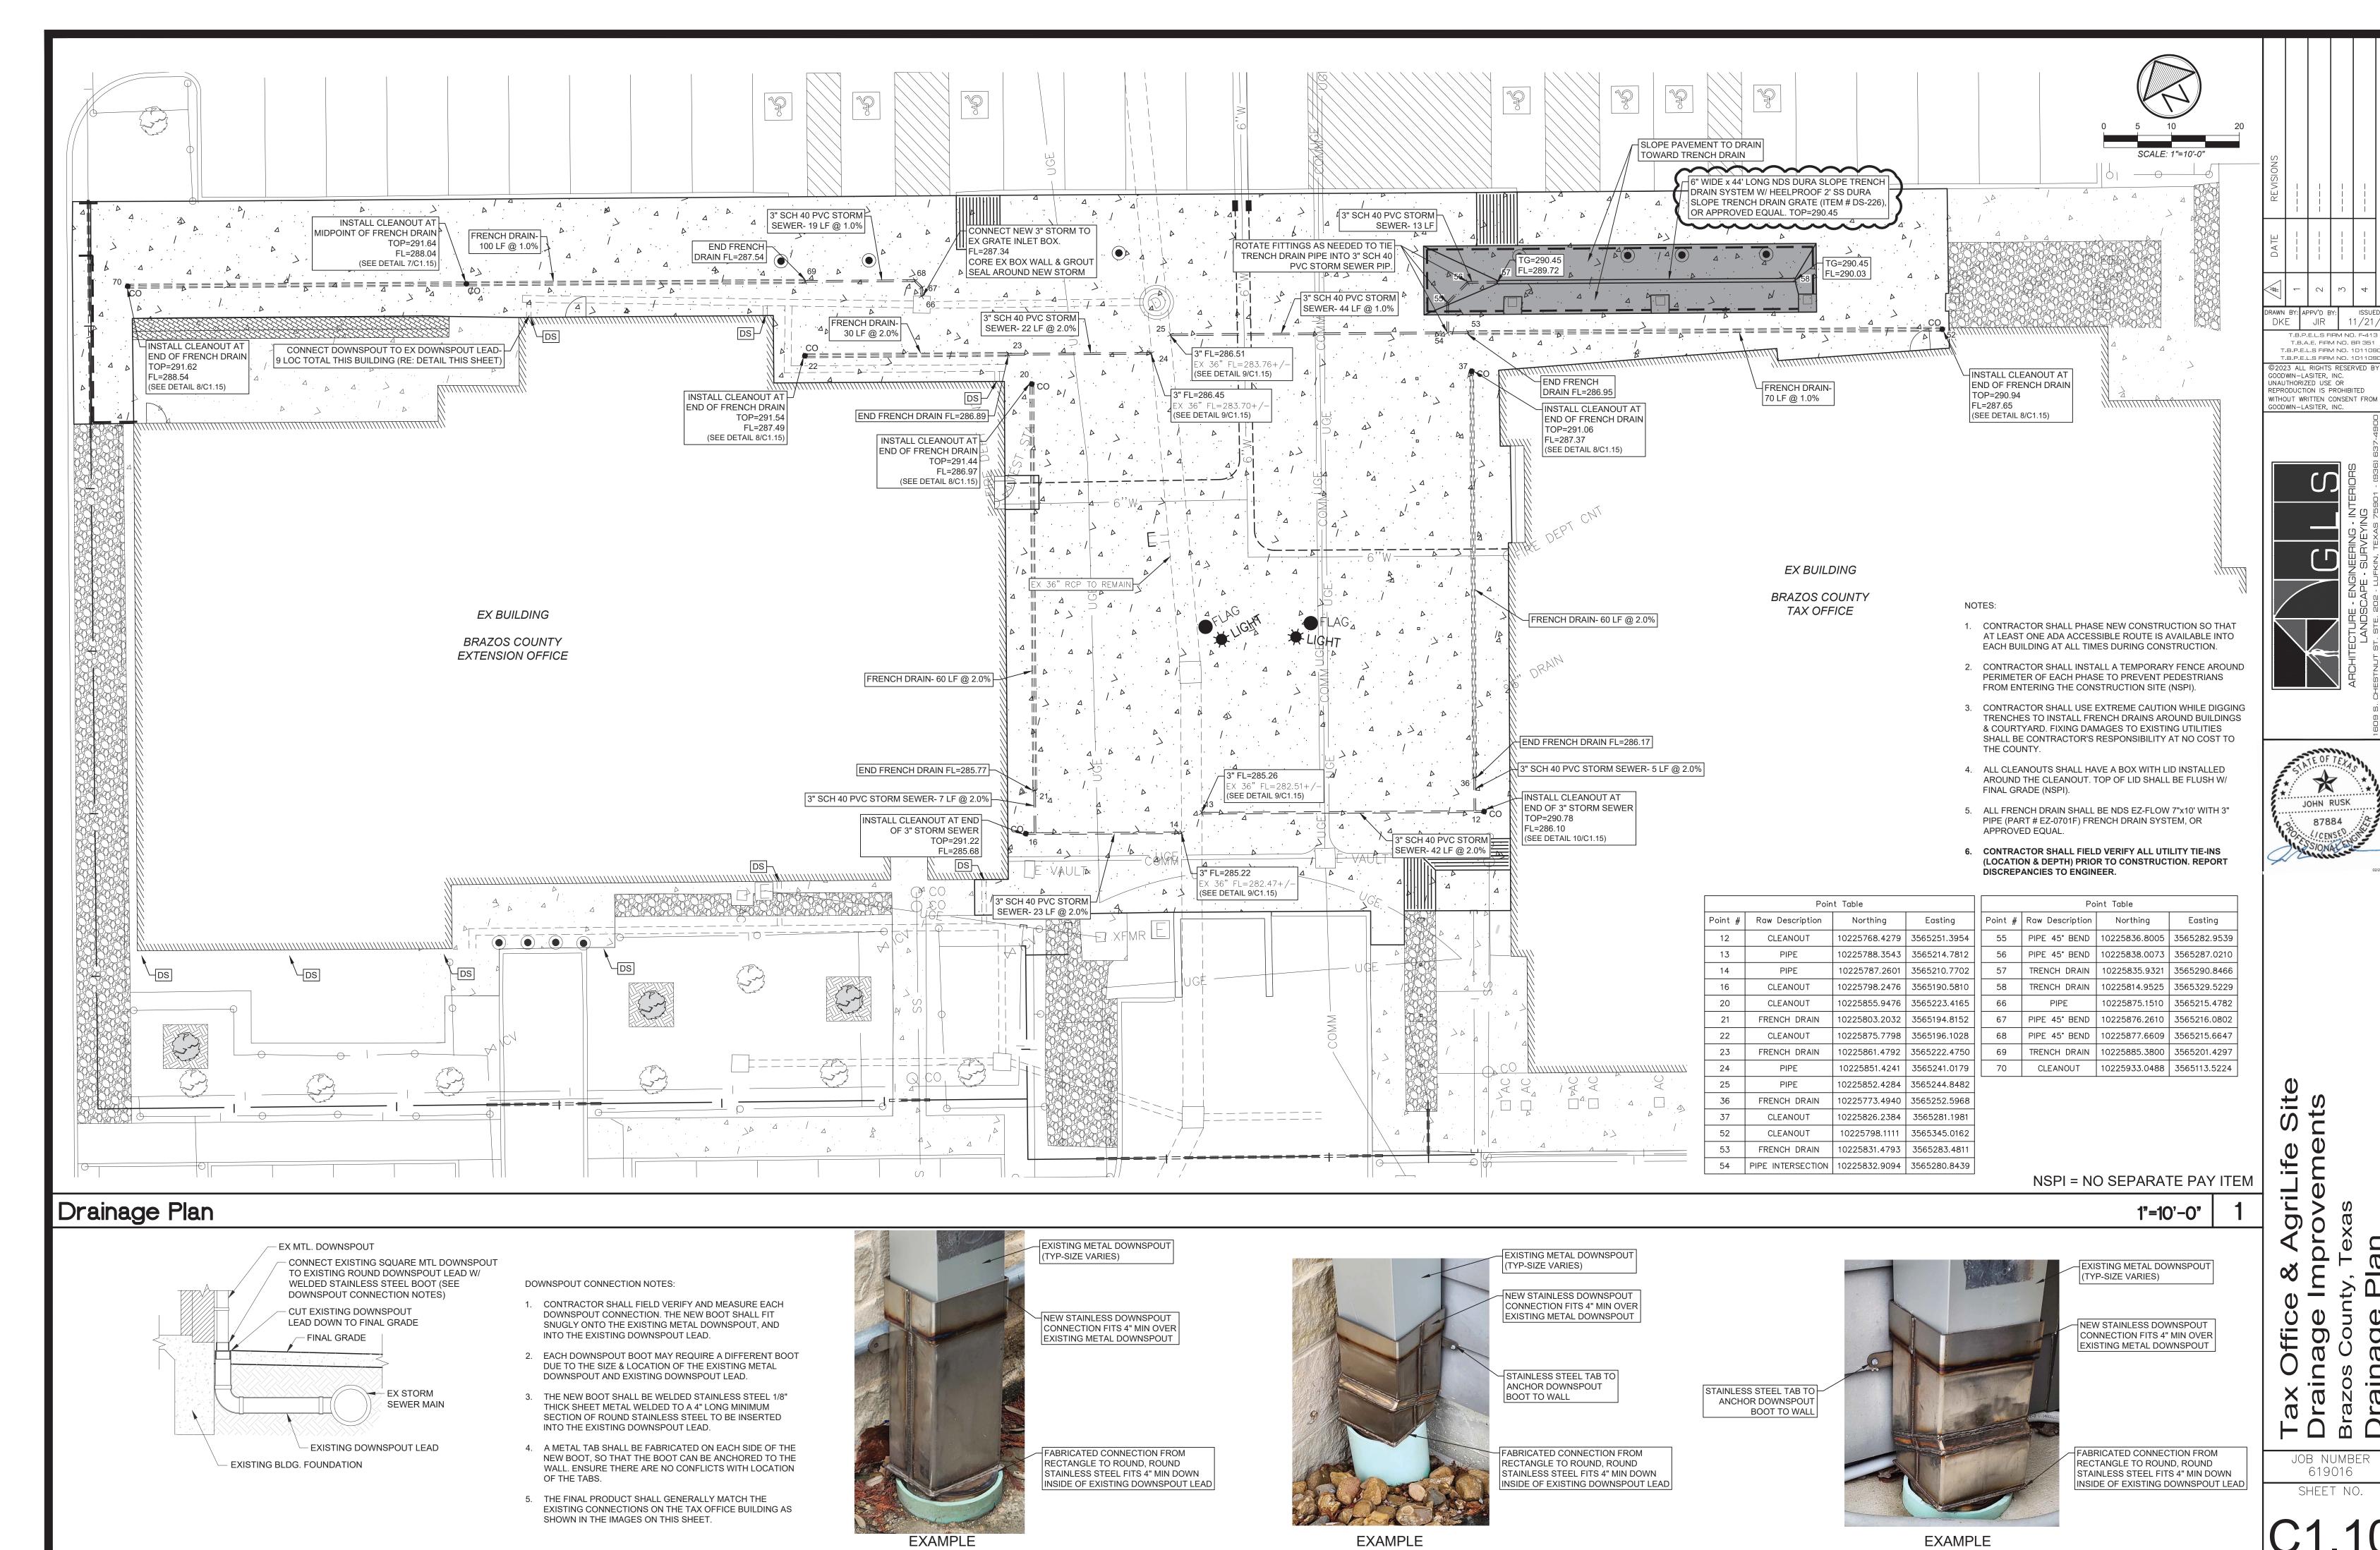

Downspout Connection Detail

7

N.T.S. | 2

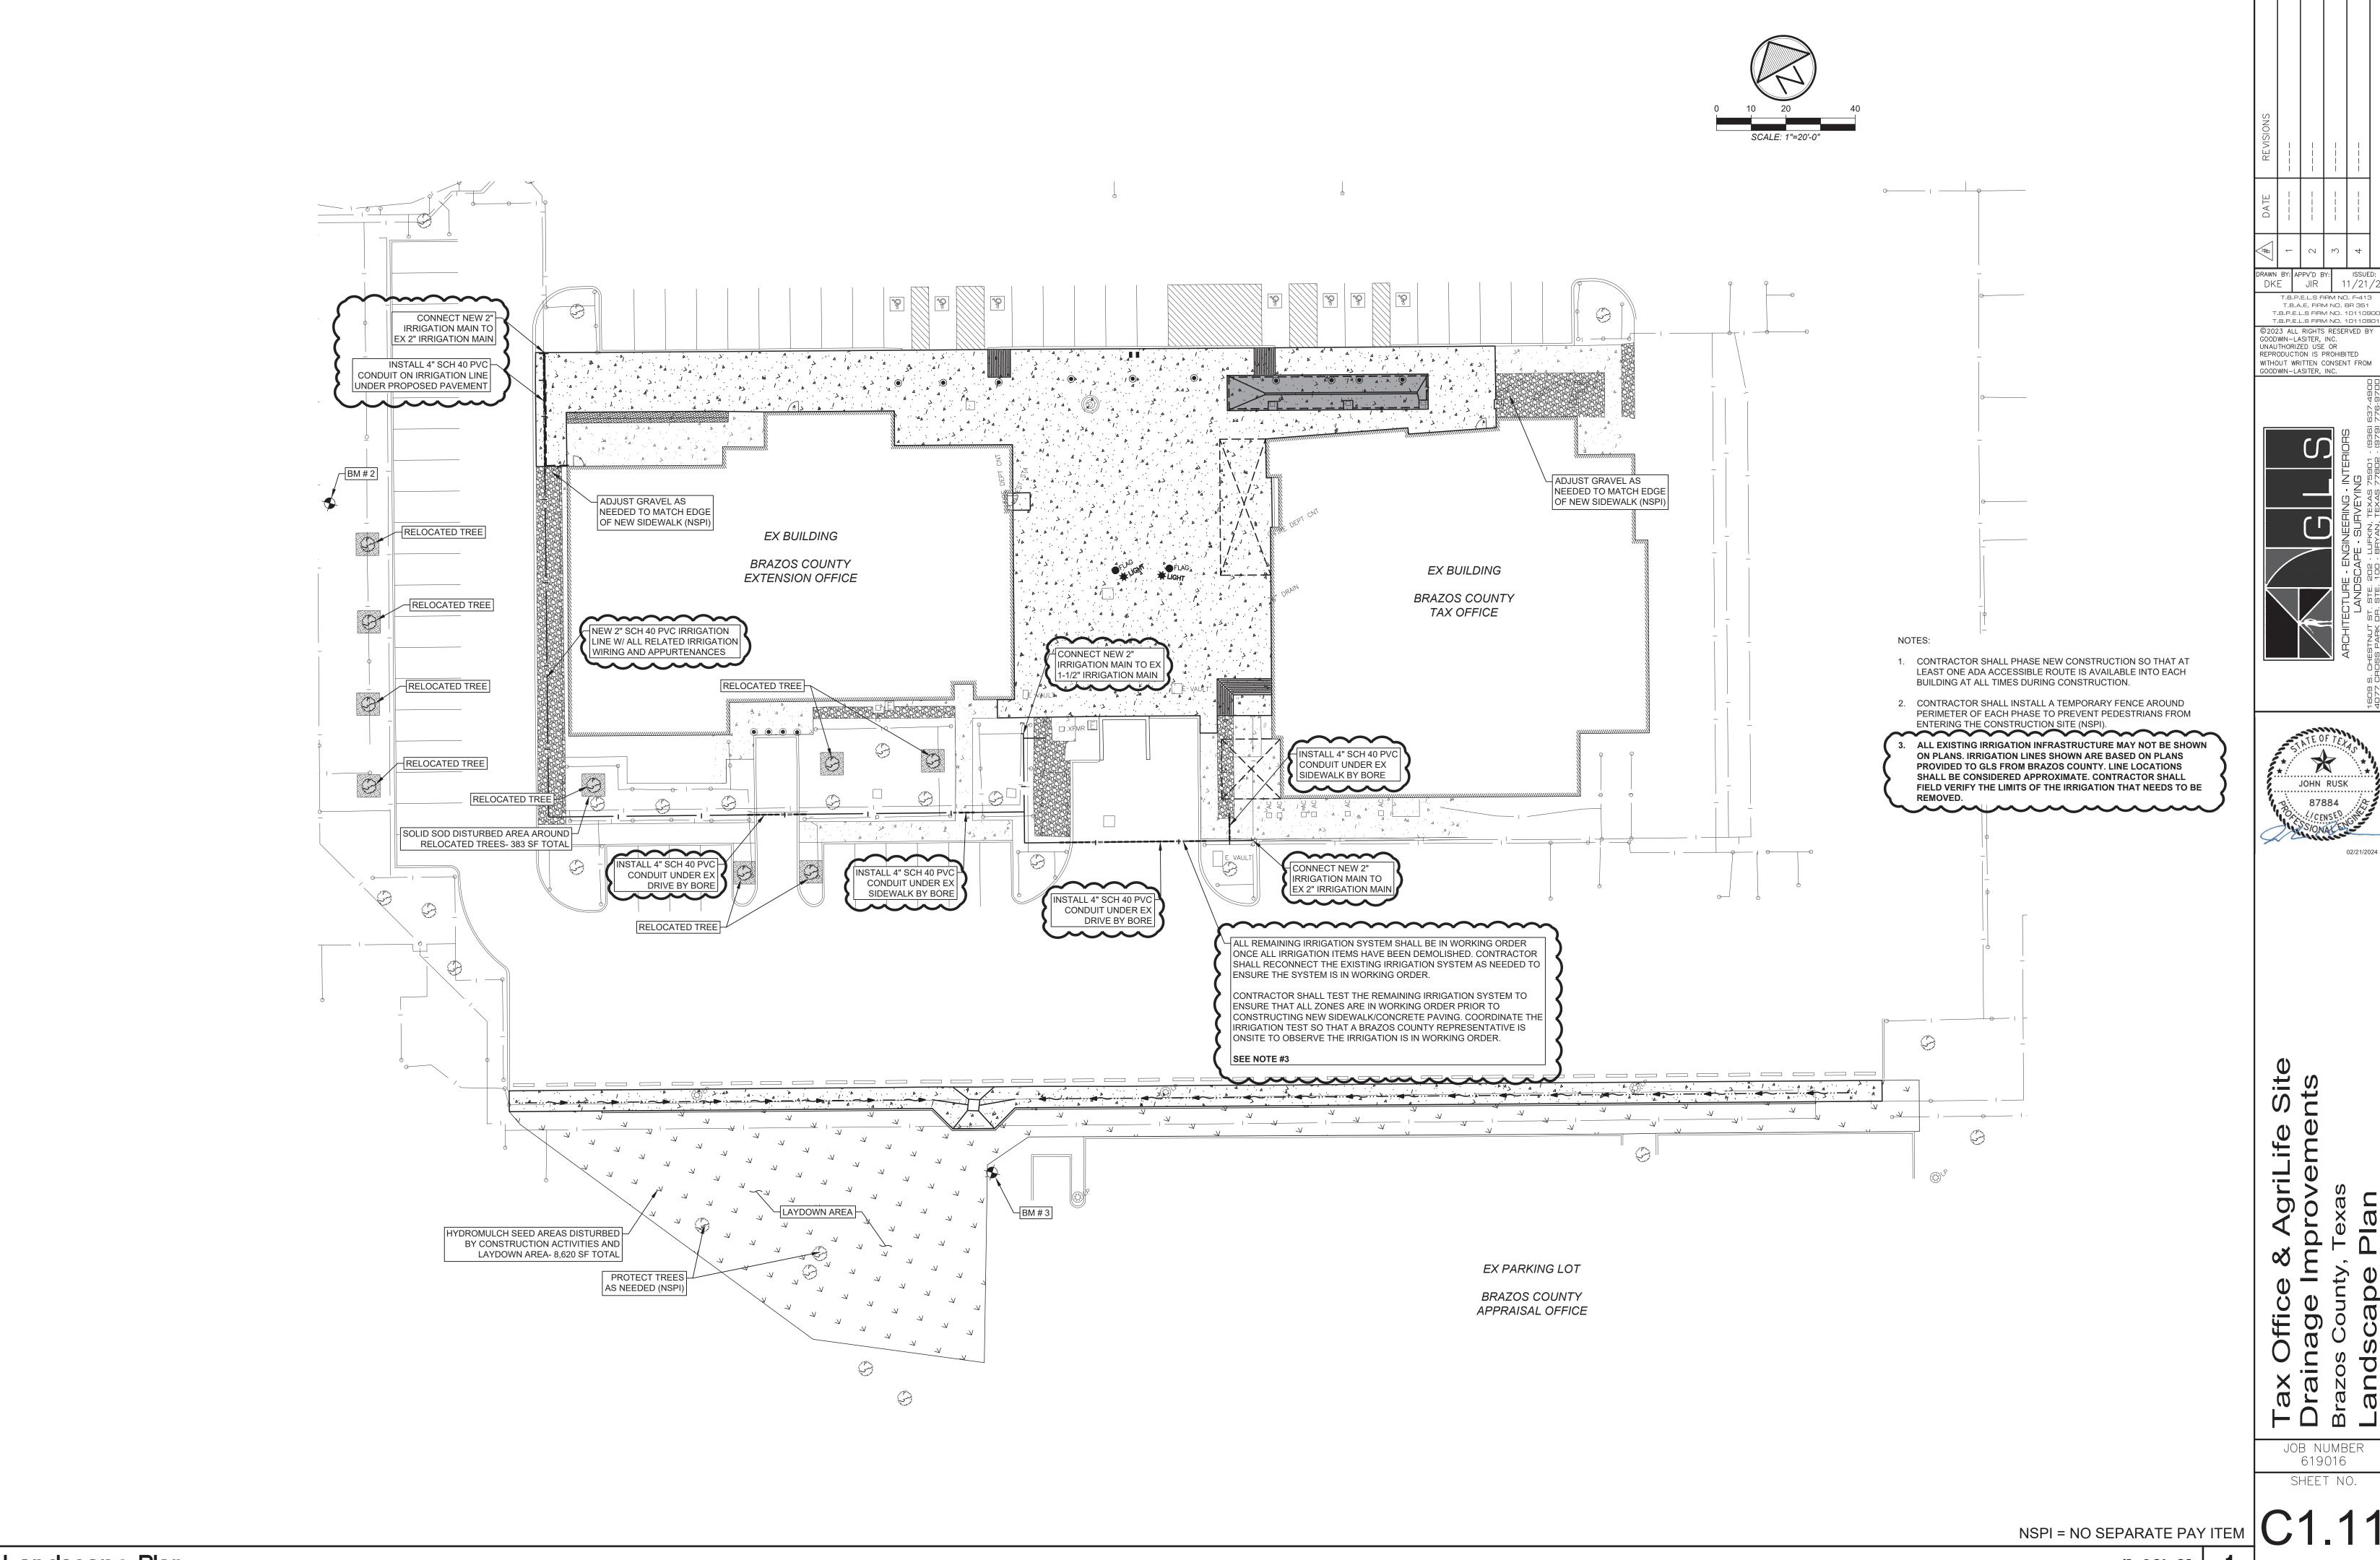

T.B.P.E.L.S FIRM NO. F-413 T.B.A.E. FIRM NO. BR 351

\* JOHN RUSK 87884

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JOB NUMBER 619016

